# **Dane County Rezone Petition**


 Application Date
 Petition Number

 11/09/2021
 DCPREZ-2021-11789

 01/25/2022
 DCPREZ-2021-11789

OV	VNER INFORMATIC	N	AGENT INFORMATION				
OWNER NAME CARBON CYCLE C	ONSULTING LLC	PHONE (with Code)		GENT NAME ASON FULLER	Code)	IE (with Area B) 370-4926	
BILLING ADDRESS (Number & Street) 464 CANAL ROAD			ADDRESS (Number & Street) PO BOX 628455				
(City, State, Zip) MARSHALL, WI 53559				ity, State, Zip) liddleton, WI 53562	2		
E-MAIL ADDRESS				MAIL ADDRESS uller.jason@yahoo.	com		
ADDRESS/L	OCATION 1	AD	DRESS/LC	OCATION 2	ADDRESS/LOCA	TION 3	
ADDRESS OR LOCA	TION OF REZONE	ADDRES	S OR LOCAT	ION OF REZONE	ADDRESS OR LOCATION	OF REZONE	
464 Canal Road							
TOWNSHIP MEDINA	SECTION 2	TOWNSHIP		SECTION	TOWNSHIP	SECTION	
PARCEL NUMBE	ERS INVOLVED	PARC	CEL NUMBER	RS INVOLVED	PARCEL NUMBERS IN	VOLVED	
0812-023	-8000-6		0812-023-9	9500-9			
		RE	ASON FOR	REZONE			
	OM DISTRICT:				STRICT:	ACRES	
FP-35 Farmland Pre	eservation District		FP-B Farm	nland Preservation	Business District	78	
C.S.M REQUIRED?	PLAT REQUIRED?		STRICTION IIRED?	INSPECTOR'S INITIALS	SIGNATURE:(Owner or Age	ent)	
Yes No	Yes No	✓ Yes	☐ No	RWL1			
Applicant Initials	Applicant Initials	Applicant Initi	als		PRINT NAME:  DATE:		
					1		

Form Version 04.00.00

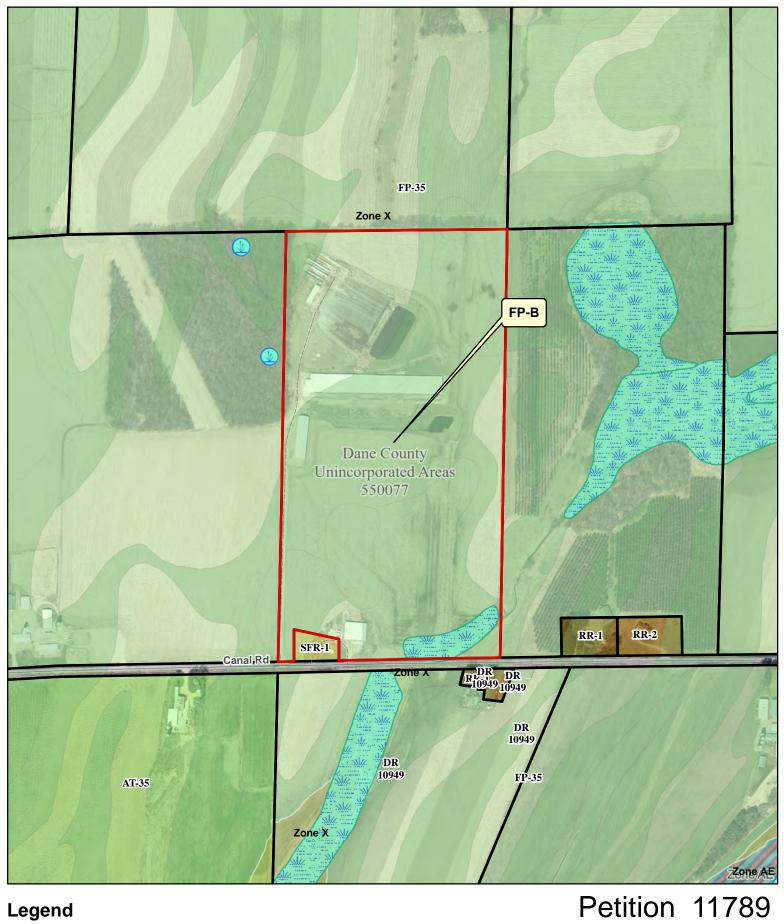





0 205 410

820 Feet

CARBON CYCLE
CONSULTING LLC



# Dane County Department of Planning and Development

Zoning Division Room 116, City-County Building 210 Martin Luther King Jr. Blvd. Madison, Wisconsin 53703 (608) 266-4266

Application	Fees
General:	\$395
Farmland Preservation:	\$495
Commercial:	\$545

- PERMIT FEES DOUBLE FOR VIOLATIONS.
- ADDITIONAL FEES MAY APPLY. CONTACT DANE COUNTY ZONING AT 608-266-4266 FOR MORE INFORMATION.

## REZONE APPLICATION

		APPLICANT I	NFORMATION		9
Property Owner Name:	Carbon Cycle	Consulting	Agent Name:	Susan	follo
Address (Number & Street)	: 464 Caral	Rd	Address (Number & Street):		8455
Address (City, State, Zip):	Marshall WZ	- 5559	Address (City, State, Zip):		ton WZ 535W
Email Address:			Email Address:	Eller &	lason Q Yaprov. con
Phone#:	6087704920		Phone#:	608-37	
		PROPERTY IN	IFORMATION		
Township: Me din	6	Parcel Number(s):	081202380	1-80	081202395009
Section:		rty Address or Location:	35.77	12/	shull 42 53559
		REZONE DI	ESCRIPTION		
request. Include both cur relevant information. For	rrent and proposed land or more significant develop	uses, number of parcels of parcels of parcels of parcels of parcels of parcels of the parcel	ailed explanation of the reader lots to be created, and a additional pages as needed	ny other I.	Is this application being submitted to correct a violation? Yes No
The accounts i	s in formand	Presidentian a	1 charlet Se 16	terarize	ed as turn lead Proservat
The property in Business - Floring Composting previous in, with	s in formand P-B under S. 10 manure an owner. N addition of a	Presunting and 1.23. The period other agent owner by-	I shall be ca property was pricultural products, for	tegoriza prev by-pra rul sir cont	iously used for educts by the milar materials included composting.
- Business - Fl Composting previous in, with	P-B under S. 10 manure as owner, N addition of a gzoning	nd other agester by-	property was pricultural products, for products, for	tegoriza prev by-pra rul sin cont	iously used for educts by the milar materials inued composting.  Acres
- Business - Fl Composting previous in, with	P-B under S. 10 manure an owner, N addition of a	nd other agester by-	property was pricultural products, for products, for posed Zoning District(s)	prev by-pra d sin cont	iously used for oducts by the milar materials includ composting.
Existing District PP-B5  Applications will no to determine that information from	manure and owner, No addition of a gening rict(s)  t be accepted until all necessary inform the checklist bel	the applicant has comation has been proposed in the proposed proposed in the applicant be ap	original was products, for contacted the town a covided. Only completely was producted. Note that	nd consulete application by the	iously used for poducts by the materials inued composting.  Acres

and understand that submittal of false or incorrect information may be grounds for denial. Permission is hereby granted for Department staff to access the property if necessary to collect information as part of the review of this application. Any agent signing below verifies that he/she has the consent of the owner to file the application.

Owner/Agent Signature\_\_\_\_\_

Date 10/13/21

### SUPPLEMENTAL INFORMATION FOR COMMERCIAL DEVELOPMENT

A scaled site plan and detailed operations plan must be submitted for commercial rezone applications. Please use the checklist below to ensure you are submitting all required information applicable to your request. Please attach the relevant maps and plans listed below to your application form.


☐ SCALED SITE PLAN. Show sufficient of	detail on 11" x 17" paper. Include the following information, as applicable:
☐ Scale and north arrow	,
☐ Date the site plan was created	
☐ Existing subject property lot lines and o	dimensions
☐ Existing and proposed wastewater treat	tment systems and wells
☐ All buildings and all outdoor use and/or	storage areas, existing and proposed, including provisions for water andsewer.
☐ All dimension and required setbacks, si	de yards and rear yards
☐ Location and width of all existing and p	proposed driveway entrances onto public and private roadways, and of all interior roads or driveways.
☐ Location and dimensions of any existing	g utilities, easements or rights-of-way
☐ Parking lot layout in compliance with s.	. 10.102(8)
☐ Proposed loading/unloading areas	
☐ Zoning district boundaries in the immed	diate area. All districts on the property and on all neighboring properties must be clearly labeled.
☐ All relevant natural features, including a archeological features, and slopes over	navigable and non-navigable waters, floodplain boundaries, delineated wetland areas, natural drainage patterns, · 12% grade
☐ Location and type of proposed screening	ng, landscaping, berms or buffer areas if adjacent to a residential area
☐ Any lighting, signs, refuse dumpsters, a	and possible future expansion areas.
□ NEIGHBORHOOD CHARACTERISTICS	i. Describe existing land uses on the subject and surrounding properties.
☐ Provide a brief written statement exp	olaining the current use(s) of the property on which the rezone is proposed.
☐ Provide a brief written statement docu	umenting the current uses of surrounding properties in theneighborhood.
C OPPOSITIONAL MARRATUE Describ	- to describe following the contesting of the approximation of applicables
	e in detail the following characteristics of the operation, as applicable:
☐ Hours of operation	The second secon
	full-time equivalents and maximum number of personnel to be on the premises at any time
	noff or pollution and measures taken to mitigate impacts to neighboring properties.
	Itside and any activities, processing or other operations taking place outside an enclosed building
	nd erosion control standards under <u>Chapter 11</u> of <u>Chapter 14</u> , Dane CountyCode
Madison and Dane County Public Healt	brivate onsite wastewater treatment systems and any manure storage or management plans approved by the had Agency and/or the Dane County Land and Water ResourcesDepartment.
	trash, solid waste and recyclable materials.
accommodate increased traffic.	ghts of vehicles, and any provisions, intersection or road improvements or other measures proposed to
	re materials stored on site, and any spill containment, safety or pollution prevention measures taken
	o mitigate light-pollution impacts to neighboring properties
☐ Signage, consistent with section 10.800	0
☐ ADDITIONAL PROPERTY OWNERS. F	Provide contact information for additional property owners, if applicable.
Additional Property Owner Name(s):	
Address (Number & Street):	
Address (City, State, Zip):	
Email Address:	


### WRITTEN STATEMENT OF INTENT AND OPERATIONS PLAN

Applicants must provide a detailed written statement of intent describing the proposed conditional use along with an operational plan that explains how the conditional use will be operated. Please use the form below and provide responses, as applicable, to your proposed conditional use. Attach additional pages, if necessary.

Describe in detail the proposed conditional use. Provide the specific location of the use(s), type of equipment used, planned property improvements, including description / size of existing or proposed new buildings to be used, and any other relevant information. For existing or proposed commercial operations, provide the name of the business and describe the nature and type of business activity.
We will employ the use of trucks, tractors, composit turners & wheel loaders, mixers, & screeners
determine The site has existing infrastructure that will be used for the composting operations. Manare products from farms and digesters will be brought into the site, where it will be composted. Zero to is trucks per day are expected. Composte windrows will be turned as needed throughout day are expected. Composte windrows will be turned as needed throughout the process, Liquid manure is added to windrows as a sustainable mans to the process, Liquid manure is added to windrows as a sustainable mans to the process, and hours of operation
determine The site has existing intrastructure from farms and digesters will
be brought into the site, where it will be composted. Zero to 10 trucks for
day are expected, composite is added to windrows as a sustainable many to
They's a weekit needed generally during the hours of 6:06 Am - 10:00 on during peak season List the number of employees, including both full-time equivalents and maximum number of personnel to be on the premises at any time.
List any anticipated noise, odors, dust, soot, runoff or pollution associated with the conditional use, along with any proposed measures that will be taken to
mitigate impacts to neighboring properties
benerally low oder five to the agostic nature of corposting open will are designed to composting namine at other facilities andre
Severally low odw five to the a crobic nature of composting open areal are designed to college the rain water two pff. successfully controlling adors a dust and noise. A Jagoon will store Describe any materials proposed to be stored outside and any activities, processing or other operations taking place outside an enclosed building.
Compost rows will be contained to the active composting area. Finished products will be in the
compost rows will be contained to the active composting area. Finished products will be in the existing manure lagoon. These feature storage sheds, have been designed to meet NRCS standards.
For proposals involving construction of new facilities and/or infrastructure, describe, as applicable, any measures being taken to ensure compliance with
county stormwater and erosion control standards under Chapter 11 of Chapter 14, Dane County Code.  No Construction expected. Existing storm water basins manage clean runoff from not at this time. areas surrounding the composting area.
List and describe existing or proposed sanitary facilities, including adequate private onsite wastewater treatment systems, associated with the proposed
conditional use. For uses involving domestic pets or livestock, list and describe measures taken to address manure storage or management.
There is an existing tailet on site in the office.
List and describe any existing or proposed facilities for managing and removal of trash, solid waste and recyclable materials.
Describe anticipated daily traffic, types and weights of vehicles, and any provisions, intersection or road improvements or other measures proposed to
Describe anticipated daily traffic, types and weights of vehicles, and any provisions, intersection or road improvements or other measures proposed to
accommodate increased traffic. We will work with the Town if improvements are needed.
there could be truk traffic to be from 0 to 10 trucks a day dwing peak season
Provide a listing of any hazardous, toxic or explosive materials to be stored on site, and any spill containment, safety or pollution prevention measures.
Diesel Evel and L.P will be stored in their proper tanks what are already on SHE
Describe any existing or proposed outdoor lighting along with any measures that will be taken to mitigate light-pollution impacts to neighboring properties.  The Zoning Administrator may require submittal of a photometric plan for outdoor lighting if deemed necessary to determine potential impacts to neighbors.
Plan to use waters. 139hting - assort 6-8 outdoor dusk to dawn 15645
Describe any existing or proposed signage, including size, location, and materials, consistent with the county's sign ordinance found in s. 10.800.
Potenially may install a sign by the road that will comply with 5.10-800
Briefly describe the current use(s) of the property on which the conditional use is proposed.
composing manure products
Briefly describe the current uses of surrounding properties in the neighborhood.
In Field to convert production of a rouge of trees to the west

# Dane County Map

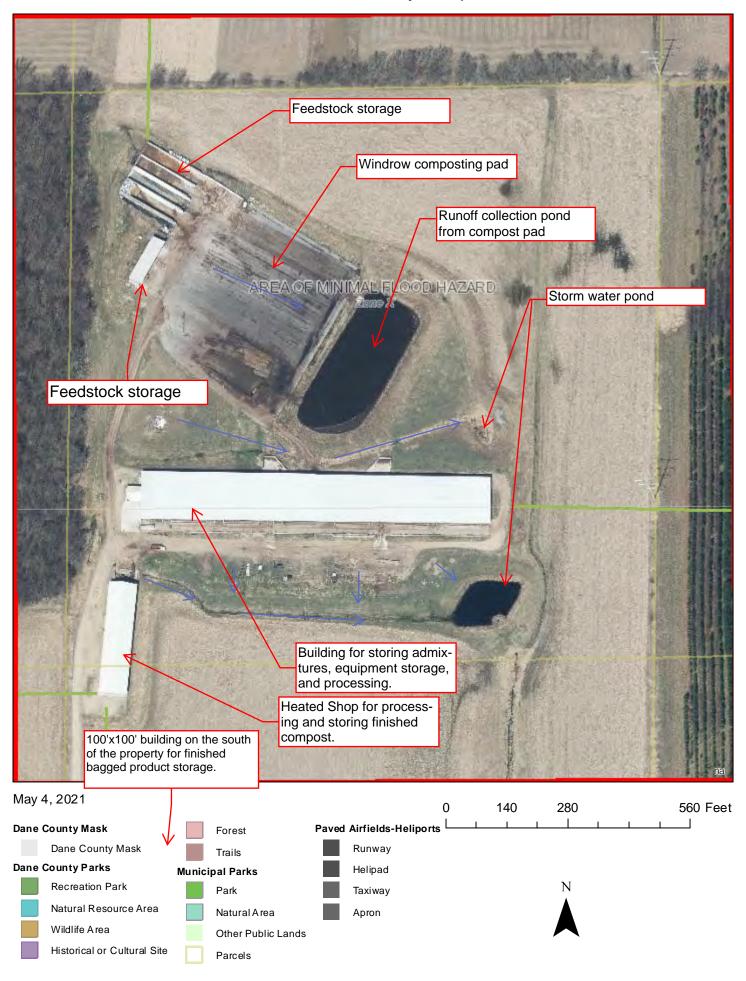

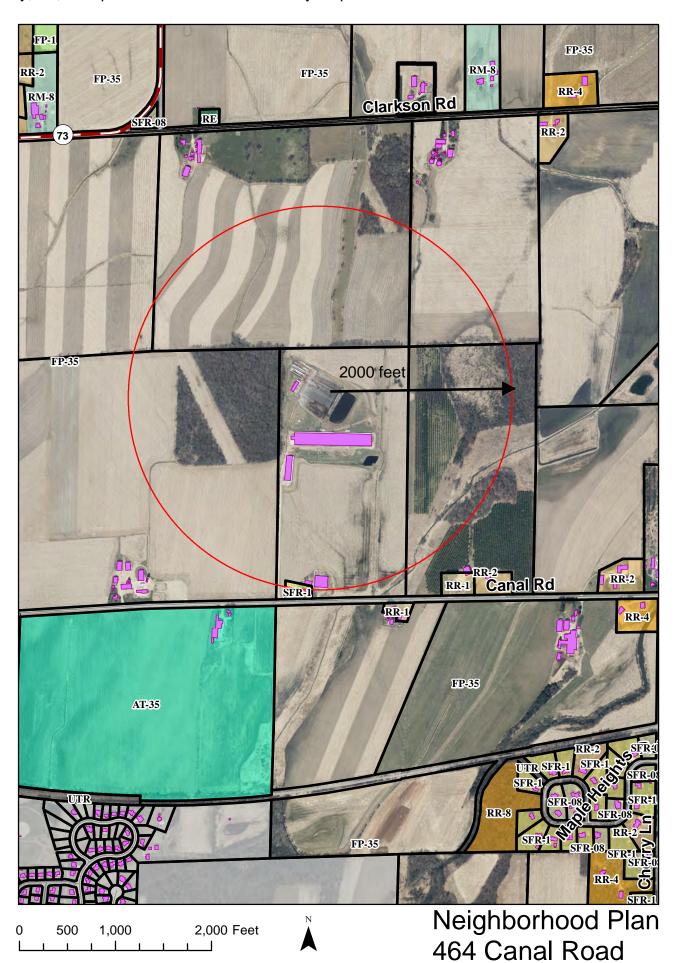


## As Built Plans Red Line (11X17)

RECEIVED

JUL 2 1 2011

DEPT. OF NATURAL RESOURCES MADISON SERV. CTR

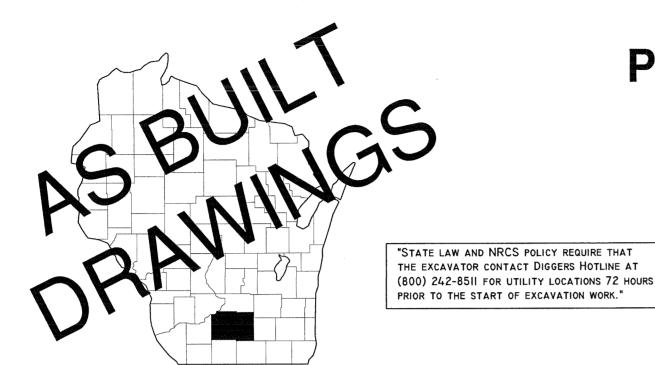

**ED HERMAN PROJECT SITE: Main FARM** 

450 CANAL ROAD

Marshall, WI 53599

Phone: 608-345-1422

NE1/4 of SW1/4, Sec. 2;


T8N, R12E

Township Of Medina

**Dane County** 



# Construction Specifications:

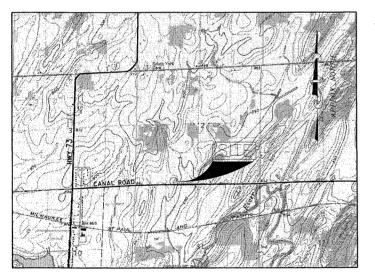

SITE LOCATION MAP

SCALE: 1" = 2000'

"Excavation" WI Constr. No. 2 "Earthfill" WI Constr. No. 3 "Concrete" WI Constr. No. 4 WI Constr. No. 8 "Drainfill" WI Constr. No. 10 "Fencing" "Geotextiles" WI Constr. No. 13

"Plastic Pipe Conduits" WI Constr. No. 15

"Topsoiling" WI Constr. No. 26

WI Constr. No. 44 "Corrugated Polyethylene Tubing" WI Constr. No. 203 "Geosynthetic Clay Liner"

WI Constr. No. 204 "Earthfill for Waste Storage Facilities"

WI DOT Section 460 "Hot Mix Asphalt Pavement"

WI DOT Construction Spec. TE-22 "Crushed Aggregate Base Course"

Drawing Index

- 1. As Built Cover Sheet
- Exist Site Plan & As Built Structures
- 3. As Built Site Plan
- As Built Enlarged Structure Plan
- **Details and Sections**
- **Details and Sections**
- As Built Ramp Details and Sections
- Road Profile and Sections
- 9. Stormwater and Erosion Plan
- 10. Seeding and Details
- 11. As Built Basin Pipe Detail

THIS DESIGN AND THESE CONSTRUCTION PLANS MEET WISCONSIN NRCS STANDARDS: 313 "WASTE STORAGE FACILITY", 634 "MANURE TRANSFER",

1	. 1
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JUDGMENT, THIS DESIGN AND CONSTRUCTION PLAN MEETS THE MINIMUM REQUIREMENTS OF THE NRCS STANDARD 313 "WASTE

IT IS NOT TO BE LOANED, COPIED OR DUPLICATED IN ANY MANNER WITHOUT THE PERMISSION OF TIRY ENGINEERING



220 1/2 N. Bridge Street P.O. Box 44 Chippewa Falls, WI 54729 Office: (715) 723-6777 Fax: (715) 723-6842

www.tiryengineering.com

DESIGNED	:
Mich	nael J. Tiry P.E.
DRAWN:	DGB/JCC


PROJECT MANAGER:


IF THIS BAR DOES NOT MEASURE 1' THEN DRAWING IS NOT TO SCALE


-ATTENTION-


-SHEET DESCRIPTION-AS BUILT COVER SHEET -CLIENT-


HERM-02-09 04-18-11 Ed Herman SHEET 1 OF 10

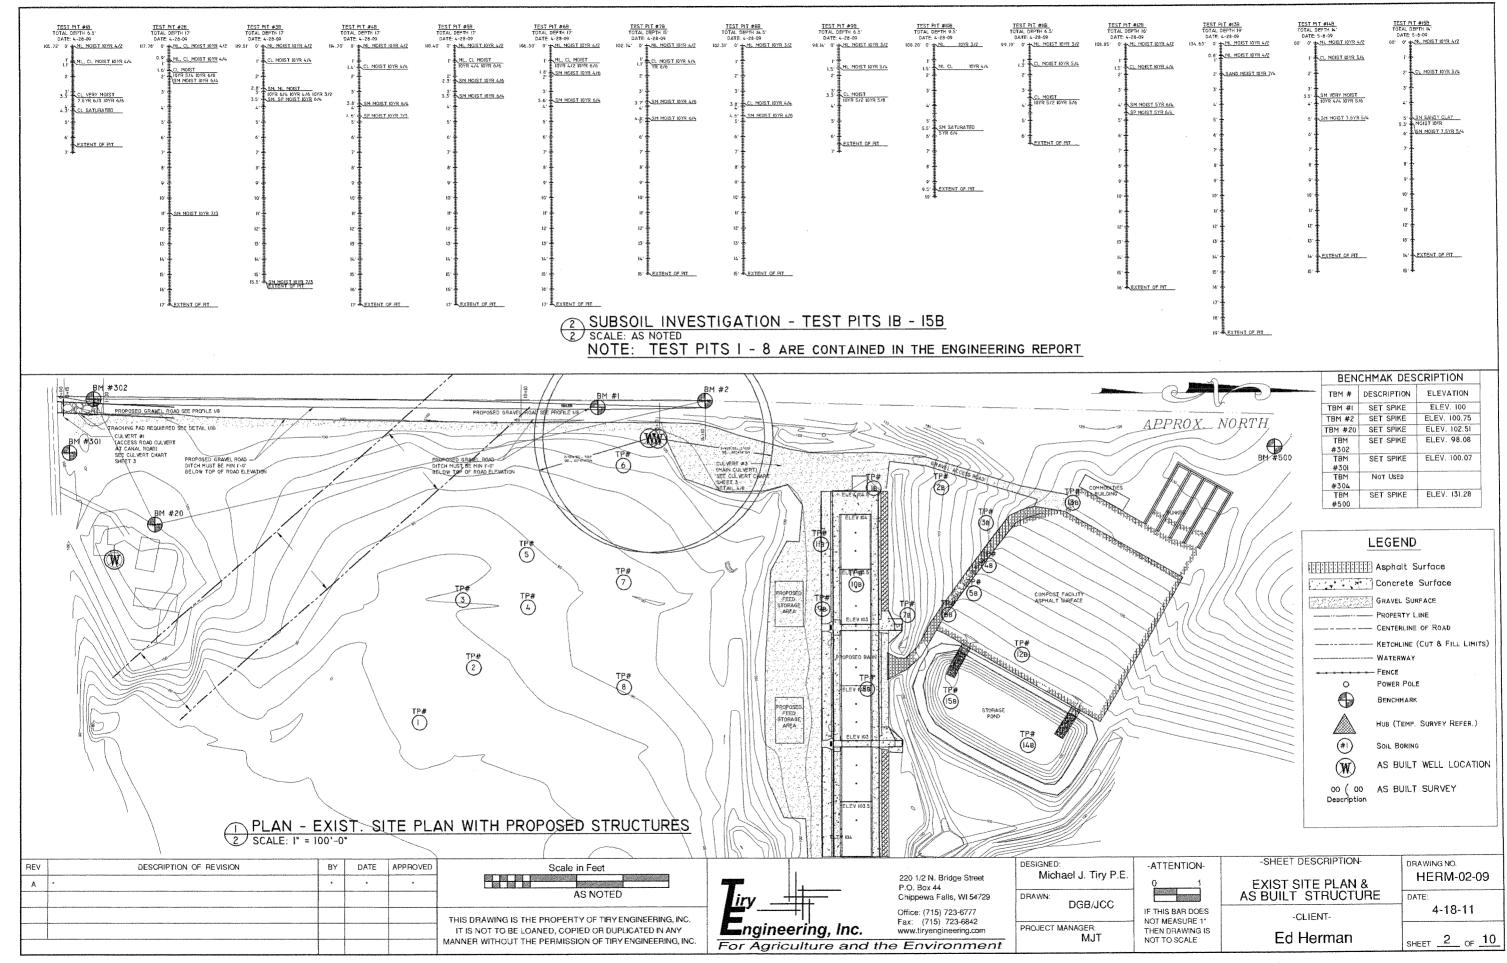


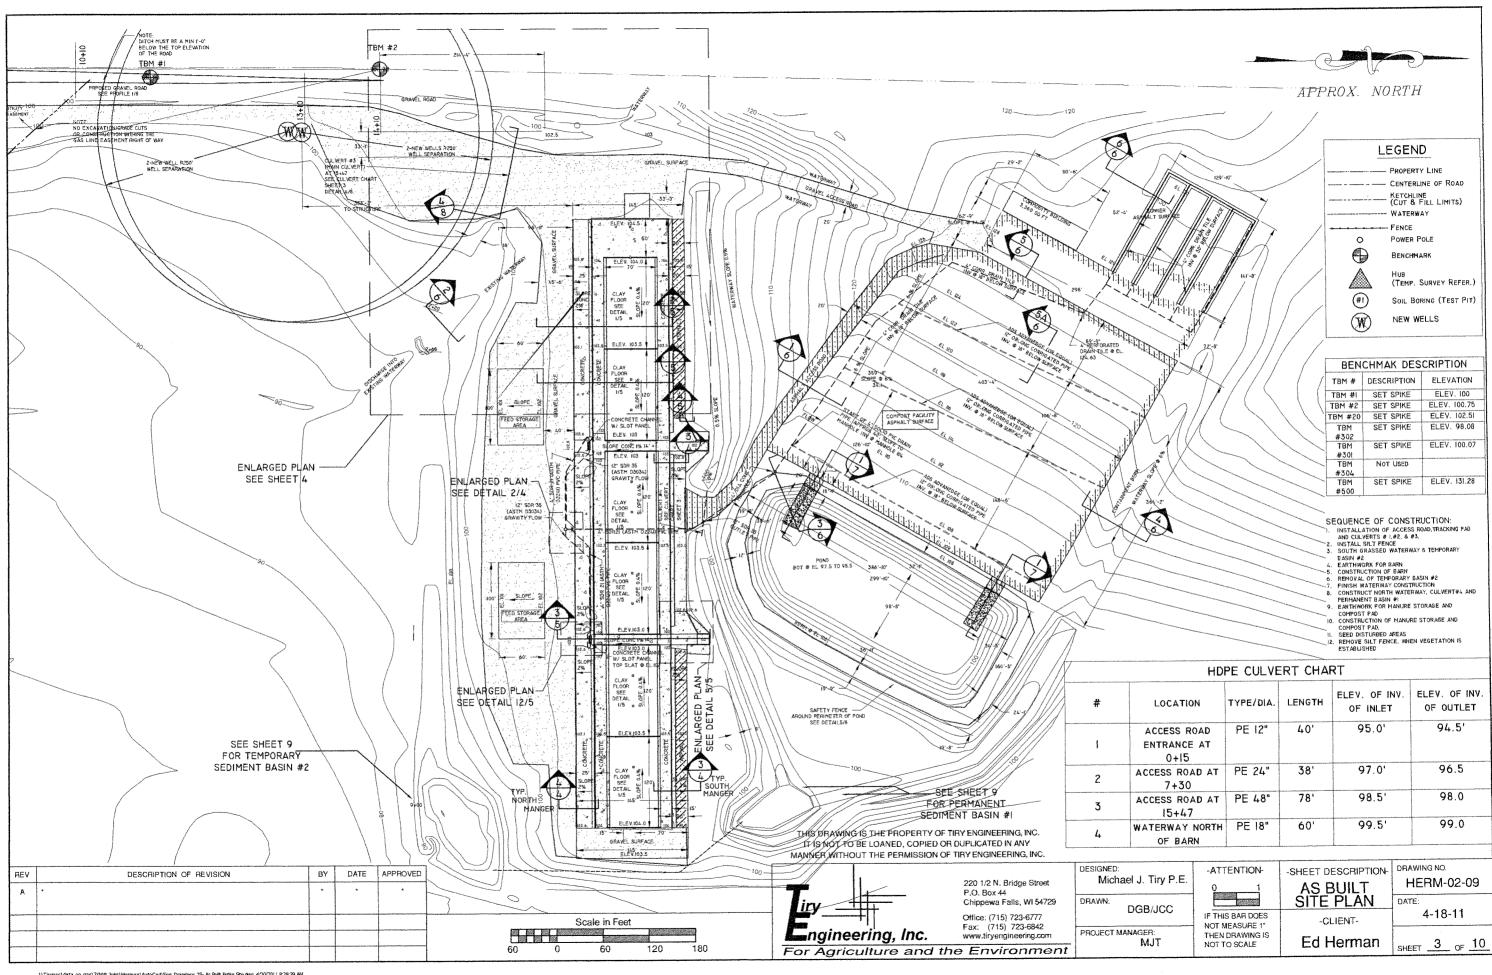


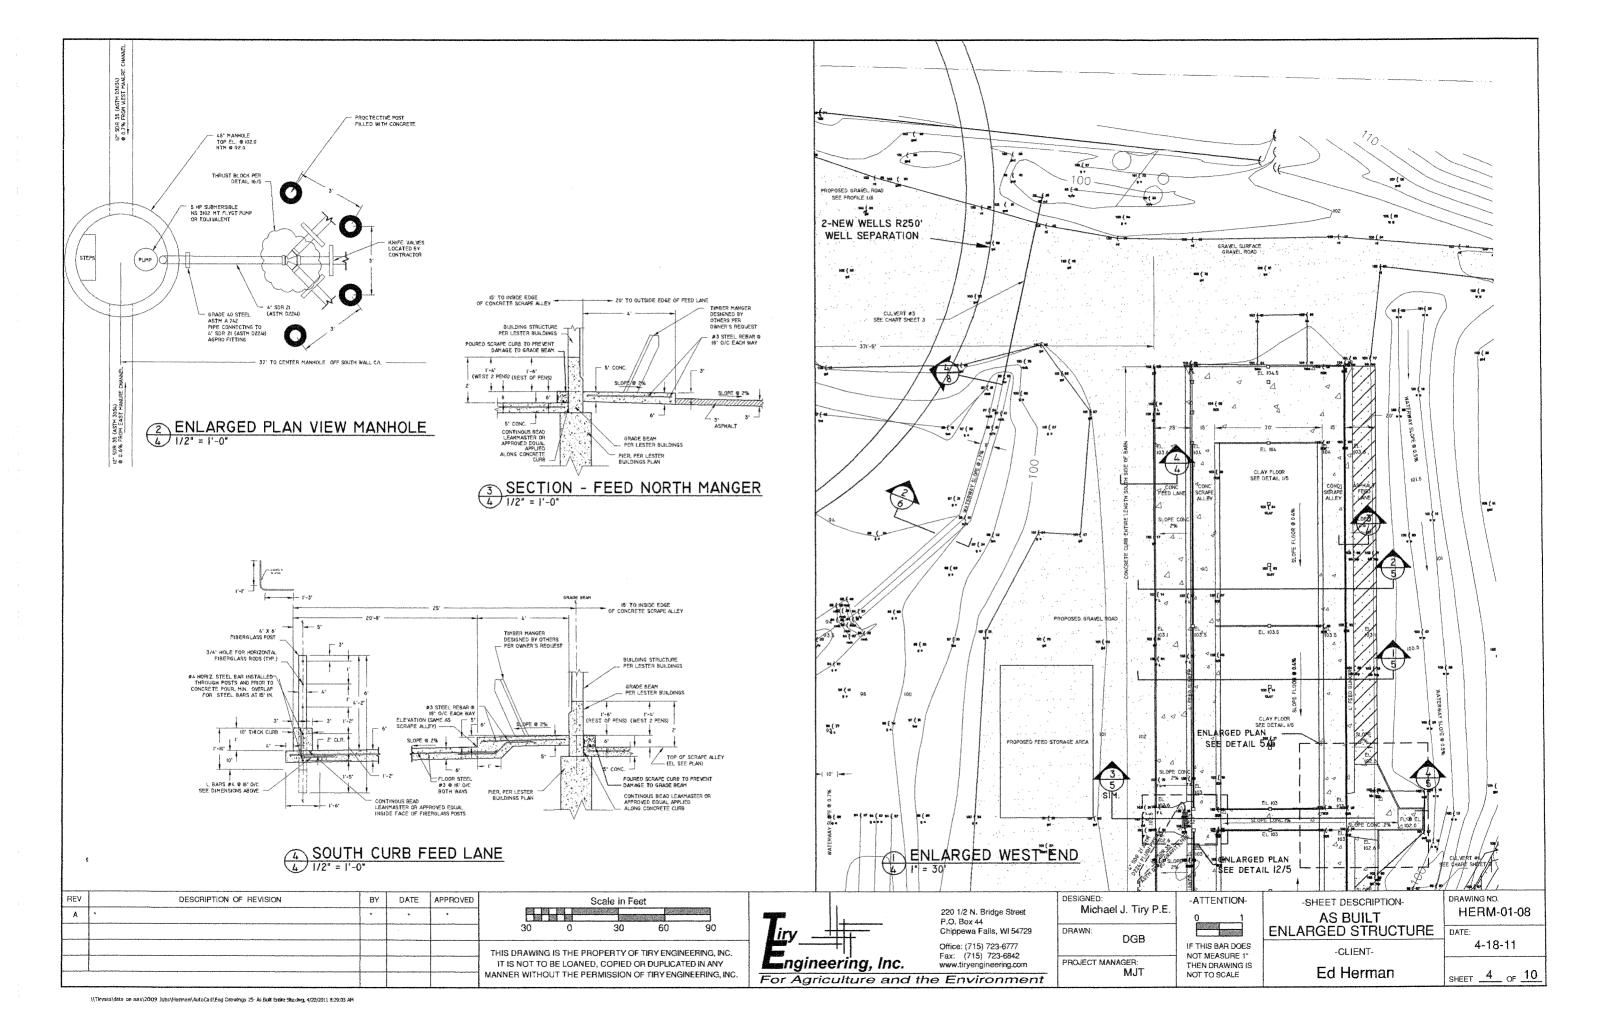


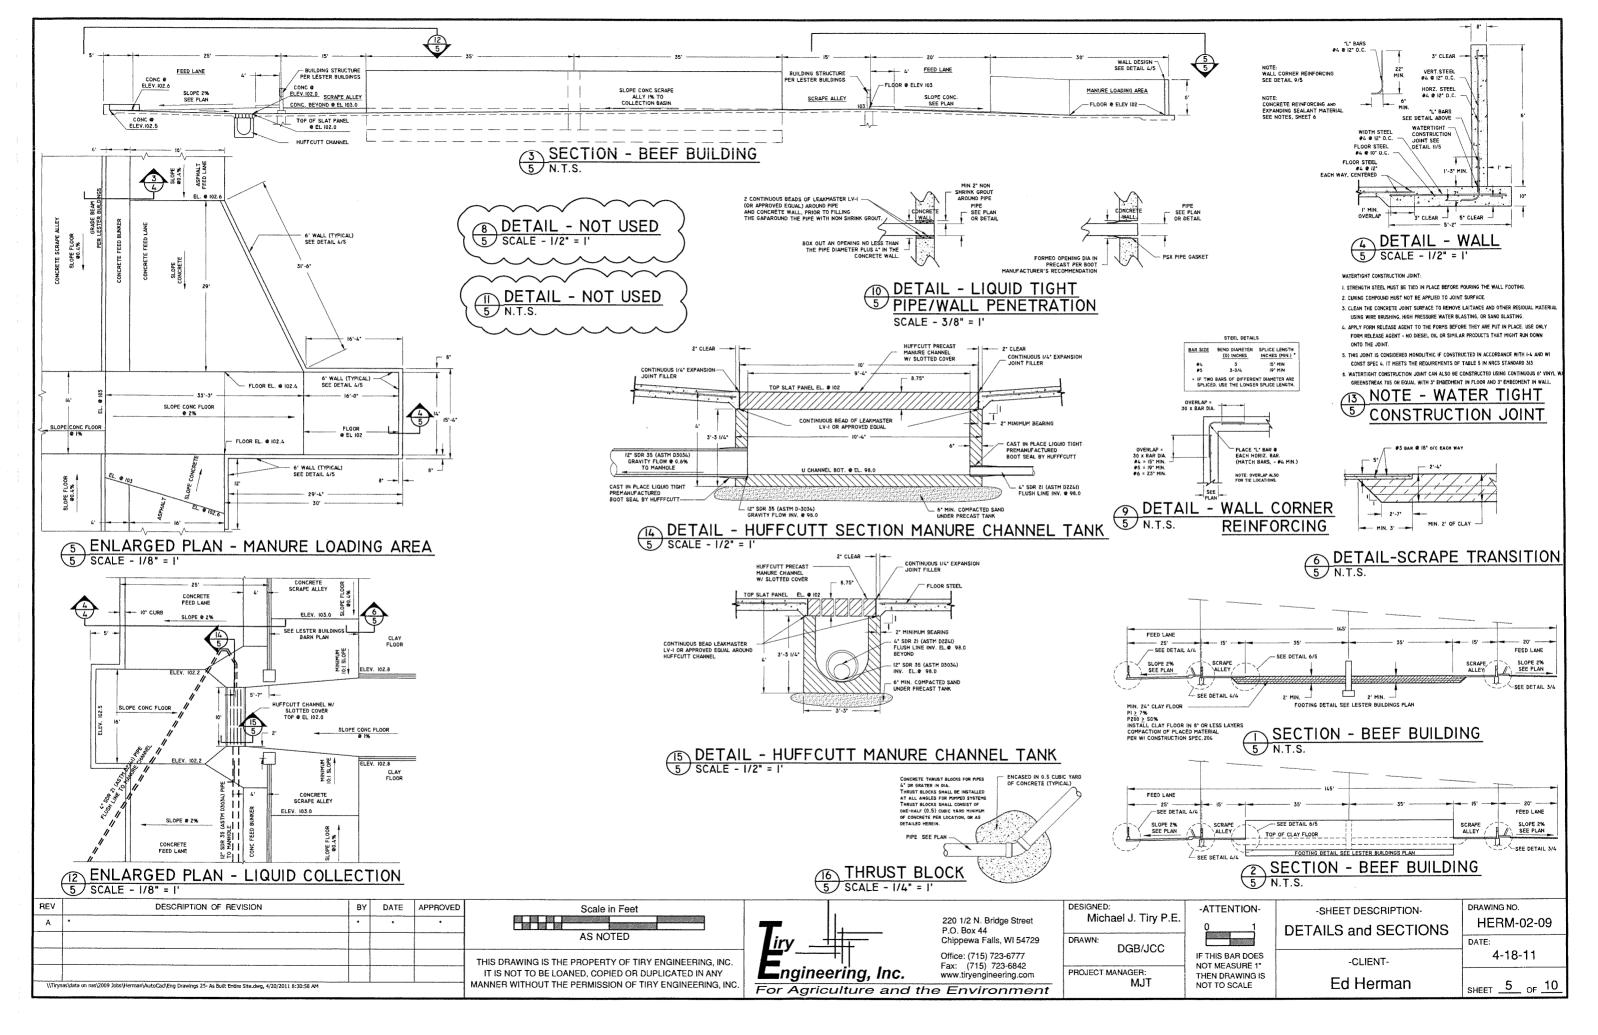

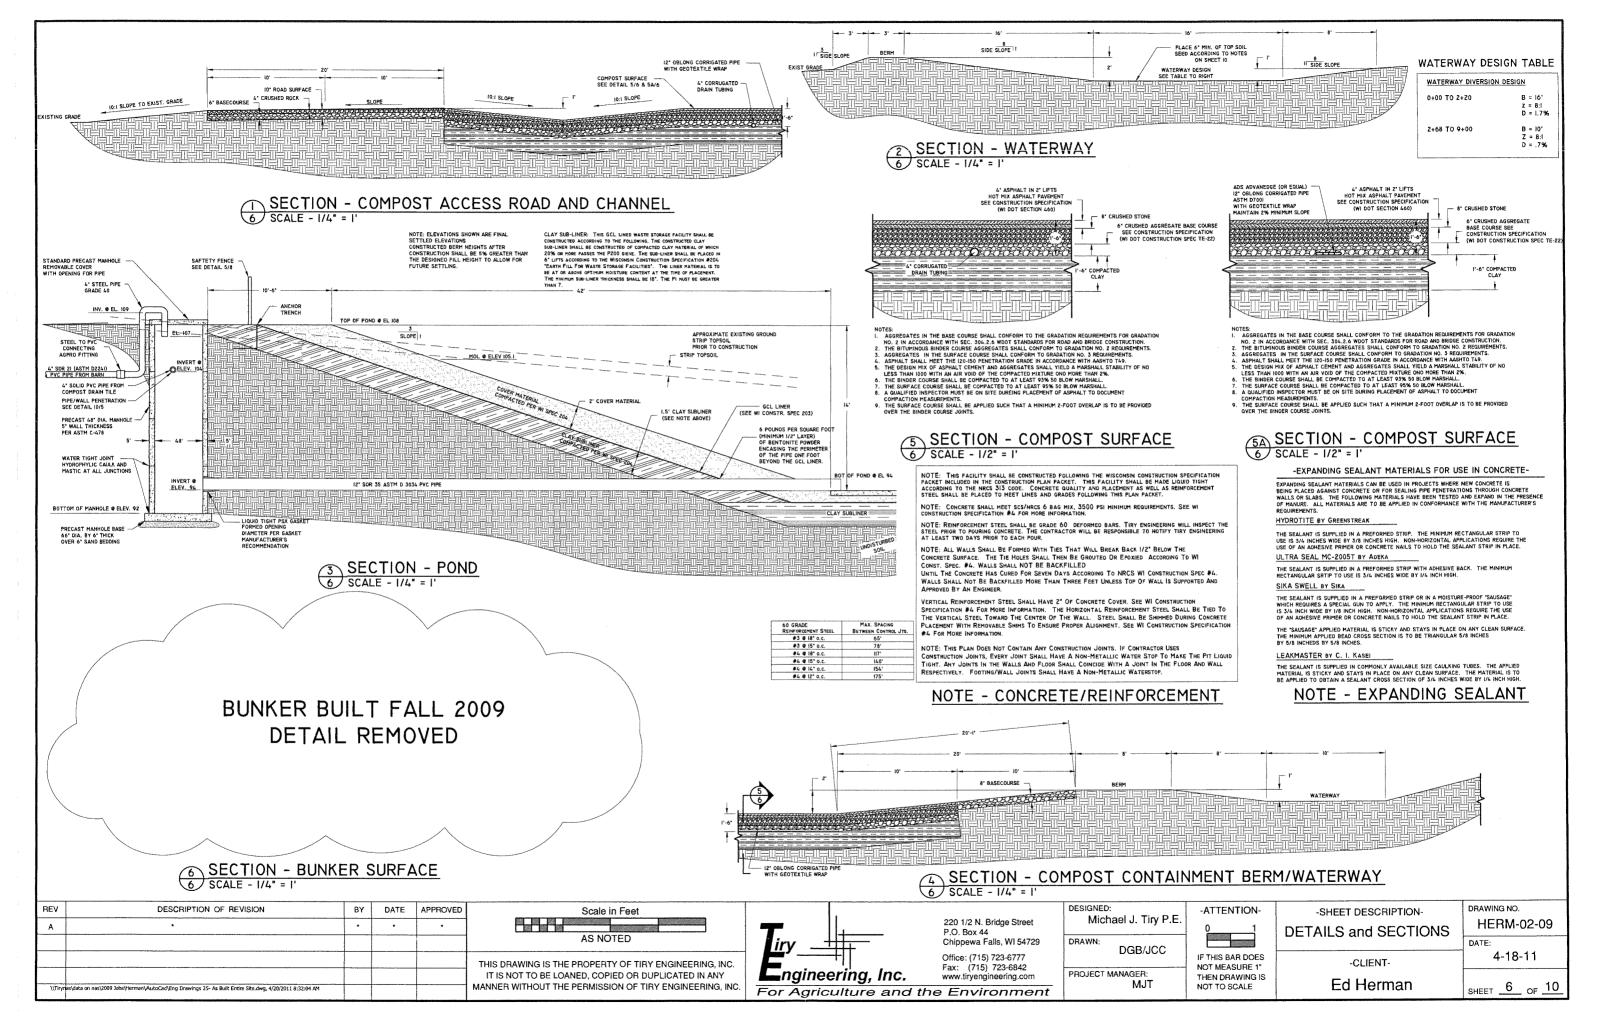

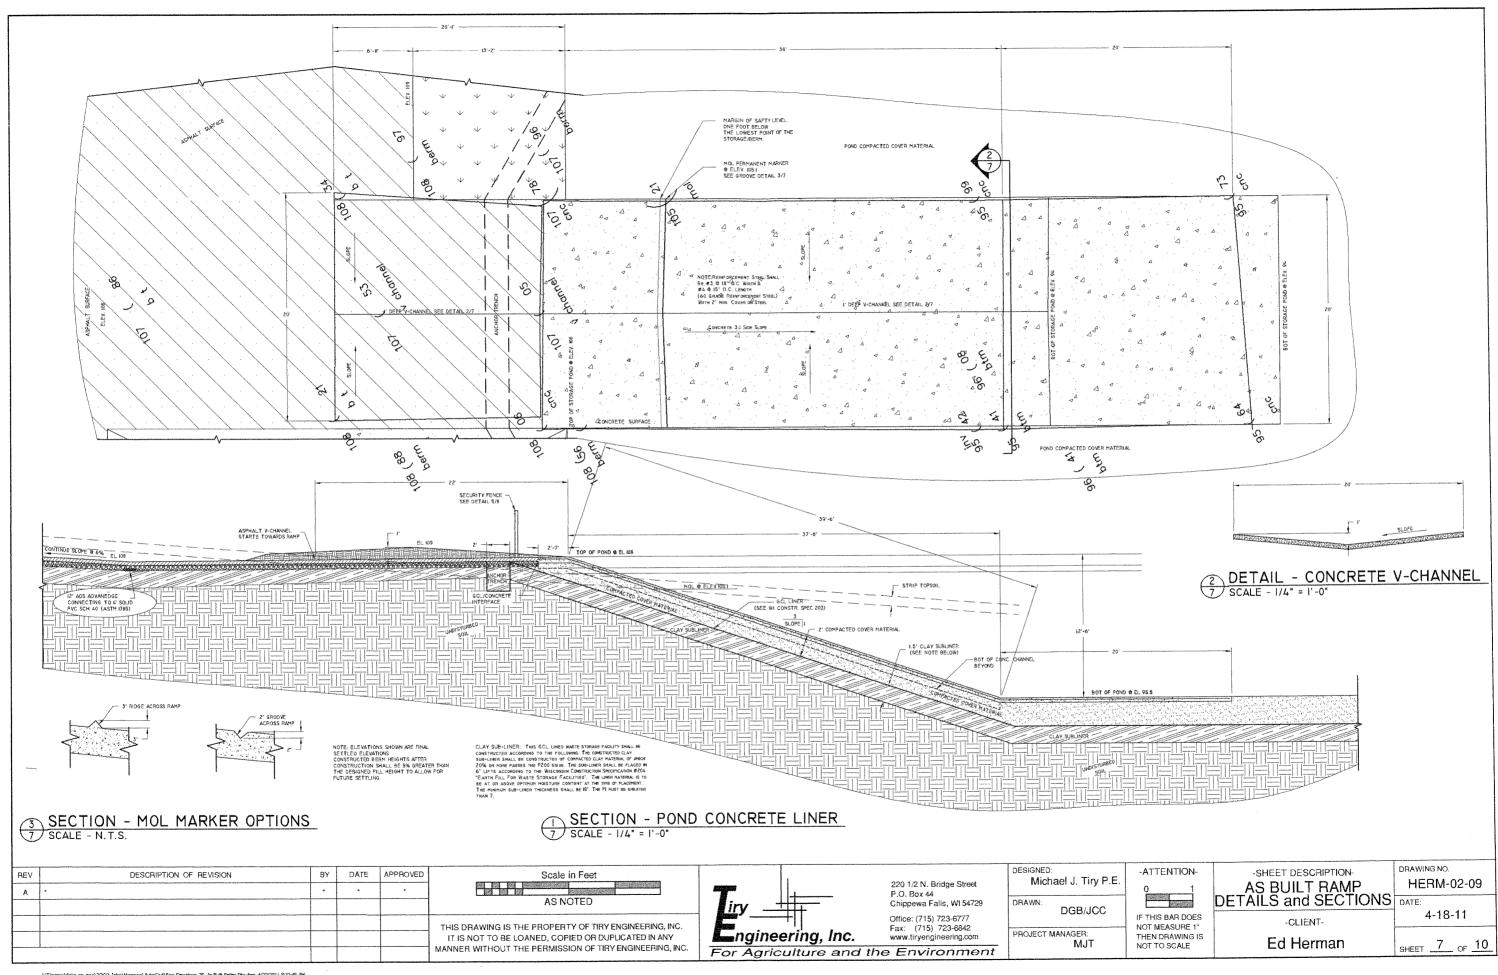

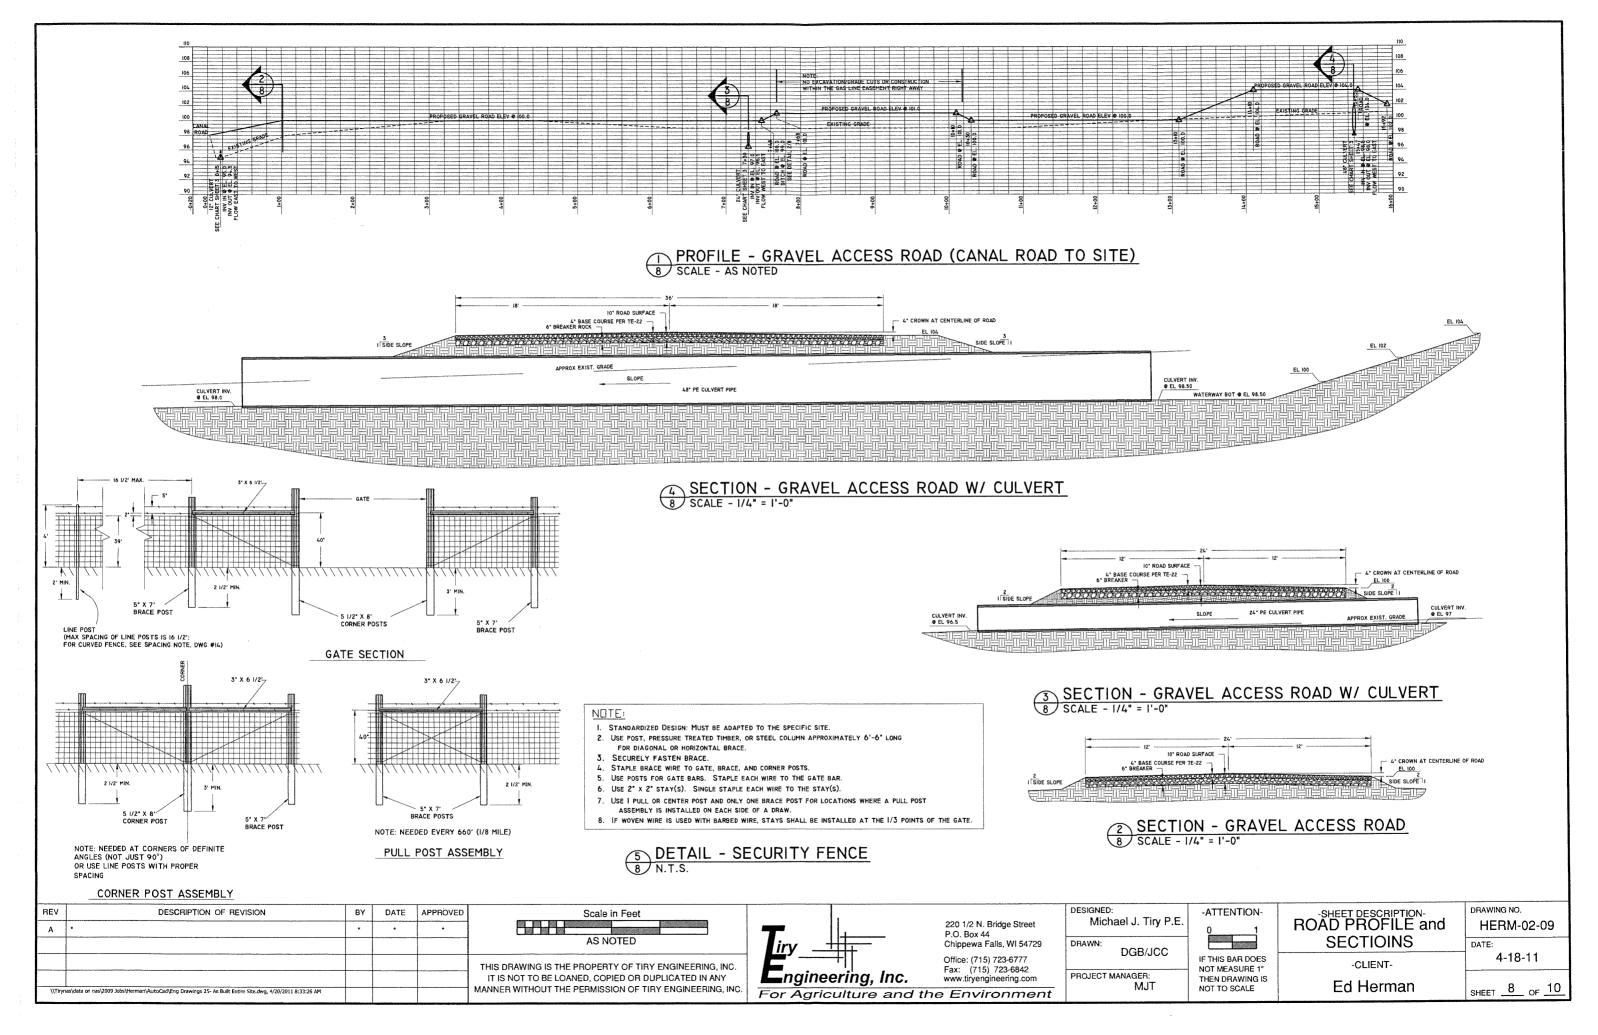

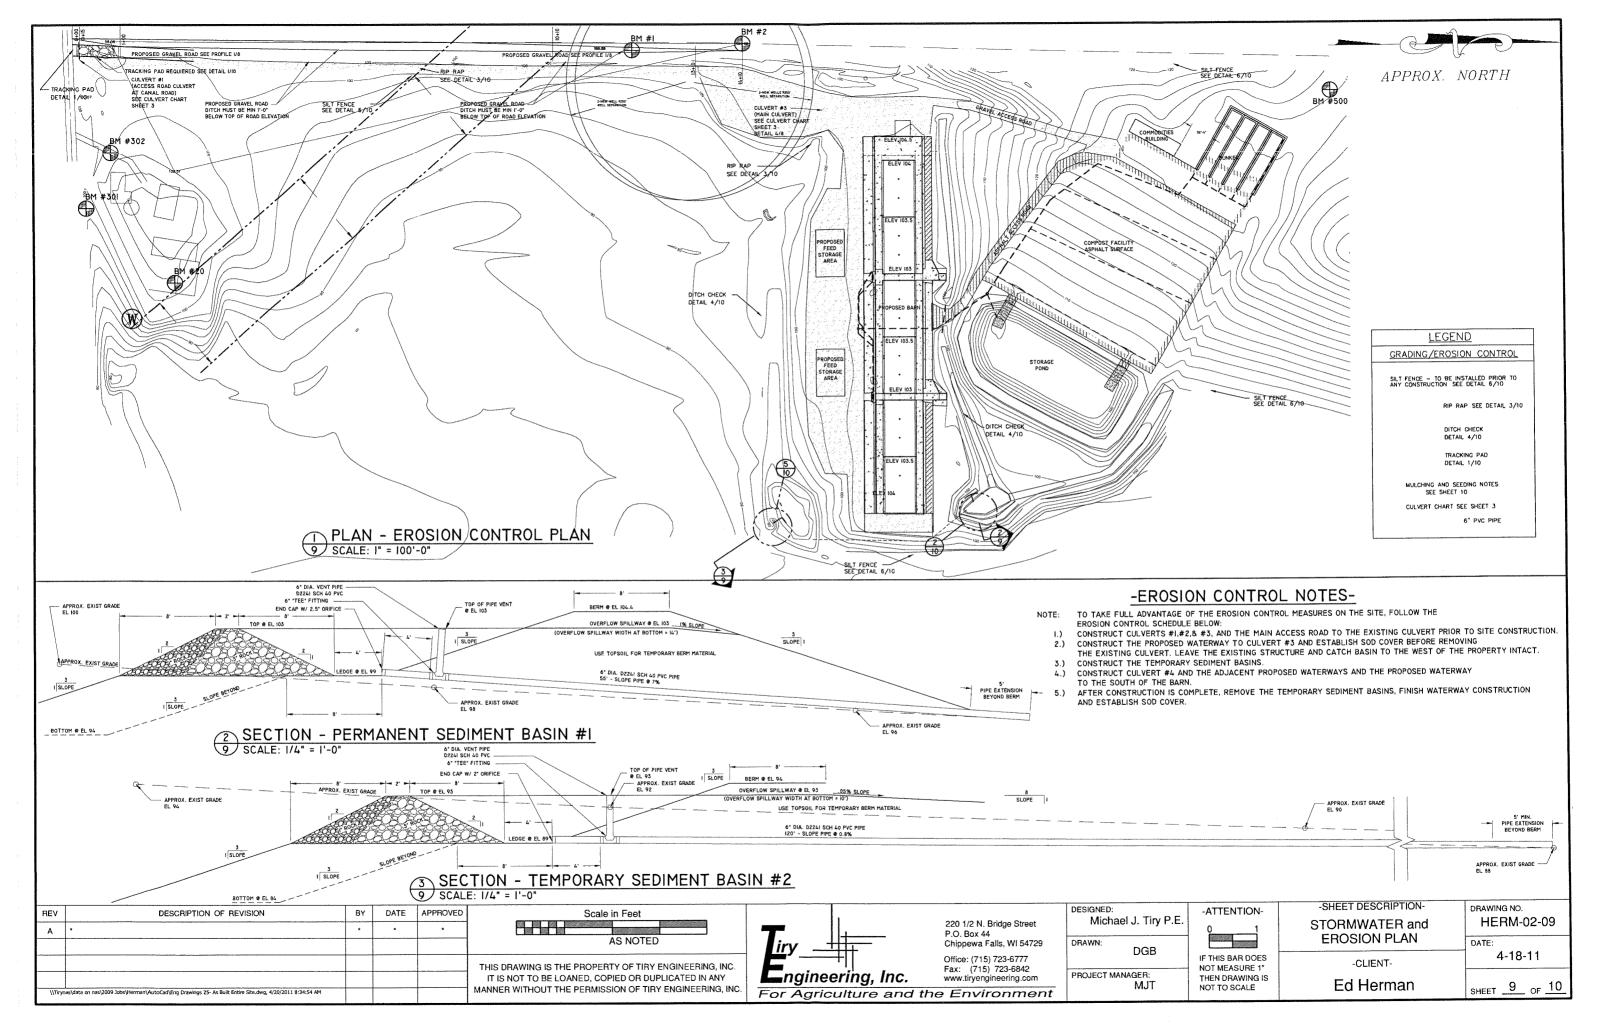

## INTRODUCED SPECIES ESTABLISHMENT

#### SEEDING DATES

TIME PERIOD		DATES		TYPE OF SEEDING
SPRING	4/1	THROUGH	5/15	PERMANENT
SUMMER	5/15	THROUGH	6/30	TEMPORARY *
LATE SUMMER	6/30	THROUGH	8/7	PERMANENT
FALL	8/7	THROUGH	8/29	TEMPORARY *
LATE FALL	8/29	THRDUGH	SNOW COVER	DORMANT
WINTER	No snow cover	THROUGH	4/1	FROST SEED

#### MATERIALS

APPLY LIME AT THE RATE DE 2 TONS PER ACRE.

APPLY 150-200 POUNDS PER ACRE OF 20 - 10 - 10 FERTILIZER

MULCH WITH 1-1/2 TONS PER ACRE OF STRAW OR HAY REASONABLY FREE FROM GRAIN AND WEED SEED. IF OTHER MULCH MATERIALS ARE USED, THE RATE OF APPLICATION SHALL MEET THE MANUFACTURER'S RECOMMENDATIONS

- SEED A TEMPORARY COVER CROP OF RYE AT A RATE OF 2 BUSHELS/ACRE.
- A PERMANENT SEEDING SHALL BE COMPLETED DURING THE NEXT ACCEPTABLE TIME PERIOD FOLLOWING A TEMPORARY SEEDING

MINIMUM PURE LIVE SEED (PLS) RATE PER ACRE AND TOTAL POUNDS OF SEED NEEDED

SEEDING MIX 3 NRCS CODE 342 - TABEL 5	LOCAT ACRES	TION DISTURBED AREAS S 10.3			
SPECIES		RATE	POUNDS		
SMOOTH BROMEGRASS		5	51		
CREEPING RED FESCUE		2	20		
KENTUCKY BLUEGRASS		2	20		
BIRDSFOOT TREFOIL		2	20		
			1		

I. PLS = (% GERMINATION X % PURITY)


#### SEEDBED PREPARATION

DURING THE RECOMMENDED SEEDING PERIODS. SEEDBED PREPARATION SHALL IMMEDIATELY FOLLOW CONSTRUCTION ACTIVITIES. PREPARE A FINE, FIRM SEEDBED TD A MINIMUM DEPTH DF 3 INCHES. SEEDING


INOCULATE LEGUMES WITH THE SPECIFIC INOCULUM FOR THE SPECIES IN ACCORDANCE WITH THE MANUFACTURER'S RECOMMENDATIONS. WHEN USING A HYDROSEFDER FIVE TIMES THE RECOMMENDED RATE OF INOCULANT SHALL BE ADDED TO THE HYDROSEEDER. INOCULANT SHALL NOT BE MIXED WITH LIQUID FERTILIZER. SEED GRASSES AND LEGUMES NO MORE THAN 1/4 INCH DEEP. SEED MAY BE BROADCAST OR DRILLED AS APPRDPRIATE TO THE SITE. SEEDING SHALL BE DONE PRIOR TO MULCHING, EXCEPT FOR DORMANT SEEDINGS


#### MULCHING


MULCHING SHALL BE DONE PRIOR TO SEEDING AND IMMEDIATELY AFTER SEEDBED PREPARATION WHEN SEEDING IS ACCOMPLISHED AS A DORMANT SEEDING. SPREAD MULCH UNIFORMLY, STRAW MULCH MATERIALS SHALL BE STABILIZED BY THE USE OF A DISK, BY A SUITABLE NON-ASPHALTIC TACKIFIER. OR BY NETTING. A DISK HARROW SHALL HAVE THE DISKS SET STRAIGHT AND THE HARROW SHALL BE USED TO ANCHOR THE STRAW MULCH INTO THE SDIL. THE TACKIFIER SHALL BE APPLIED UNIFORMLY OVER THE MULCH MATERIAL AT THE SPECIFIED RATE, OR BY INJECTING IT INTO THE MULCH MATERIAL

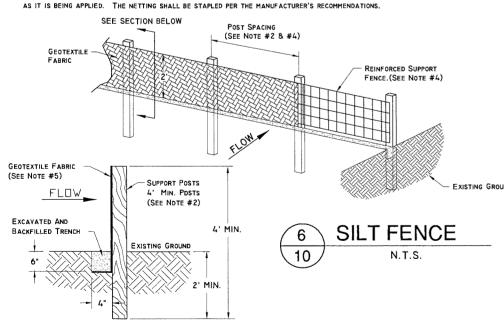

SECTION VIEW REV DESCRIPTION OF REVISION BY DATE APPROVED \\Tirynas\data on nas\\2009 Jobs\Herman\AutoCad\Eng Drawings 25- As Built Entire Site.dwg, 4/20/2011 8:35:15 A\

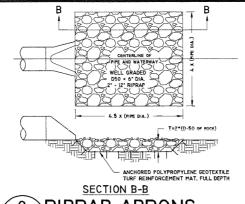

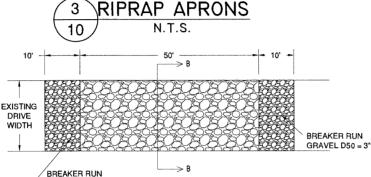

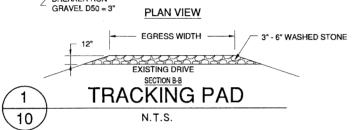


#### NOTE:


- I. THE GEOTEXTILE FABRIC SHALL BE PLACED IN THE EXCAVATED TRENCH AS SHOWN AND BACKFILLED AND COMPACTED TO THE EXISTING GROUND LINE.
- 2. WOODEN SUPPORT POSTS SHALL BE A MINIMUM DIMENSION OF 2" X 2" (NOMINAL). STEEL POSTS SHALL BE STUDDED "TEE" OR "U" TYPE WITH A MIN. WEIGHT OF 1.3 POUNDS PER LINEAL FOOT. POST SPACING SHALL BE A MAX. OF 8 FEET.
- 3. GEOTEXTILE FABRIC ATTACHED DIRECTLY TO WOODEN POSTS SHALL BE SECURED WITH
- WIRE STAPLES OR WITH WOODEN LATH AND NAILS. 4. A WIRE SUPPORT FENCE MAY BE INSTALLED TO WHICH THE GOETEXTILE FABRIC IS ATTACHEO. THE WIRE SHALL BE A MINIMUM OF 14-1/2 GAGE WOVEN WIRE WITH A MAXIMUM MESH SPACING OF 6 INCHES. POST SPACING SHALL BE A MAX. OF 10 FEET. THE GEOTEXTILE FABRIC SHALL BE FOLDED 3 INCHES OVER THE WIRE FENCE
- AND SECURED WITH STAPLES OR WIRE RINGS SPACED AT 12 INCHES.

TEST	METHOD	MIN. REQUIREMENTS(I)
GRAB TENSILE STRENGTH (POUNDS)	(4)	100
Mullen Burst Strength (Pounds/sq. in.)	ASTM D-3786	200
APPARENT OPENING SIZE (U.S. STANDARD SIEVE)	CW-02215-77 Corps of Engineers	50-80 (FINE SOILS (2)) 30-60 (COARSE SOILS (3))
WATER FLOW RATE (GAL/MIN./SQ. FT. AT 50MM CONSTANT HEAD)	(5)	10
ULTRA VIOLET RADIATION	ASTM D-4355	90

- RESULTS ON ANY ROLL IN A LOT SHOULD MEET OR EXCEED THE MINIMUM VALUES IN THE TABLE).
- 2. FINE SOILD REFERS TO SOILS WITH MORE THAN 50
- % BY WEIGHT PASSING NO. 200 SEIVE. % BY WEIGHT PASSING NO. 200 SEIVE 3. COARSE SOIL REFERS TO SOILS WITH LESS THAN 50
- 4. ASTM D-1682, GRAB TEST, METHOD 16, USING A 4 INCH BY 8 INCH SAMPLE, 3 INCH GAUGE LENGTH CLAMPED IN A I INCH LONG GRIP, TESTED AT A STRAIN RATE OF 12 INCHES/MINUTE.
- 5. WATER FLOW RATE IN GAL/MIN/SQ. FT. SHALL BE DETERMINED BY MULTIPLYING

PERMITTIVITY IN SEC. (-1) AS DETERMINED BY ASTM D-4491 BY A CONVERSION FACTOR OF

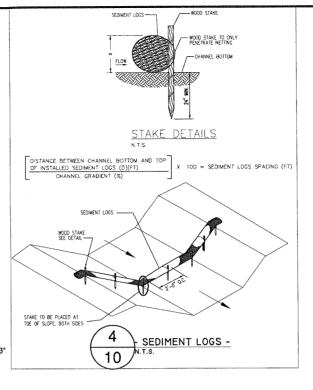

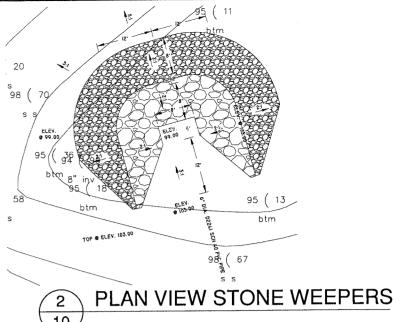

10 PLAN VIEW VIEW STONE WEEPERS

## -IMPORTANT-

FROSION AND SEDIMENT CONTROLS MUST BE ROUTINELY INSPECTED AT LEAST EVERY 7 DAYS, AND WITHIN 24 HOURS AFTER A PRECIPITATION EVENT 0.5" OR GREATER. WEEKLY WRITTEN REPORTS OF ALL INSPECTIONS MUST BE MAINTAINED BY CONTRACTOR. THE REPORT MUST CONTAIN THE FOLLOWING INFORMATION:

- A) DATE, TIME AND EXACT PLACES OF INSPECTION;
- B) NAME(S) OF INDIVIDUAL(S) PERFORMING INSPECTION;

10

- C) AN ASSESSMENT OF THE CONDITION OF EROSION AND SEDIMENT CONTROLS;
- D) A DESCRIPTION OF ANY EROSION AND SEDIMENT CONTROL IMPLEMENTATION AND MAINTENANCE PERFORMED;

E) A DESCRIPTION OF THE SITE'S PRESENT PHASE OF CONSTRUCTION.
FOR PROJECTS WHERE MORE THAN 5 ACRES ARE DISTURBED, THE MONITORING & MAINTENANCE OF THE EROSION CONTROL PRACTICES WILL BE DOCUMENTED ON THE FORM SUPPLIED BY THE WISCONSIN DNR ALONG WITH THE PERMIT.

	COLUMN OF CONTROL C	MAINTENANCE PERFORMED	PRESENT PHASE OF CONSTRUCTION
 INSPECTED BY:	CONDITION OF CONTROLS	MAINTENANCE PERFORMED	FRESENT THASE OF CONSTRUCTION
 	· · · · · · · · · · · · · · · · · · ·		

**≖**ngineering, Inc. For Agriculture and the Environment

220 1/2 N. Bridge Street P O Box 44 Chippewa Falls, WI 54729 Office: (715) 723-6777


Fax: (715) 723-6842 www.tiryengineering.com


DESIGNED -ATTENTION-Michael J. Tiry P.E DRAWN: DGB IF THIS BAR DOES NOT MEASURE 1" PROJECT MANAGER: THEN DRAWING IS NOT TO SCALE

-SHEET DESCRIPTION-**SEEDING & DETAILS** -CLIENT-Ed Herman

DRAWING NO. HERM-02-09 DATE: 4-18-11 SHEET 10 OF 10

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# SECTION - PIPE INLET FOR BASIN #1 SCALE - 1/4" = 1'-0"

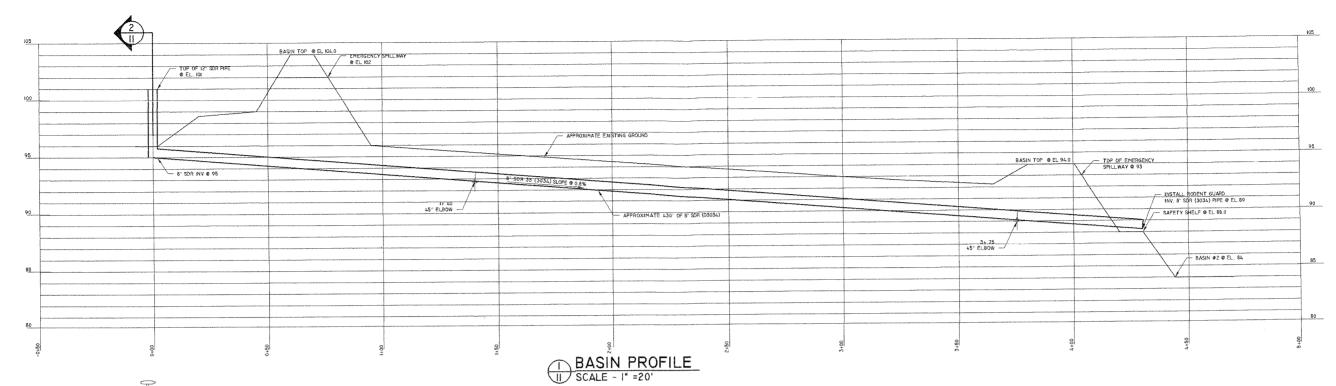REV	DESCRIPTION OF REVISION	BY	DATE	APPROVED	ļ
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Scale in Feet AS NOTED
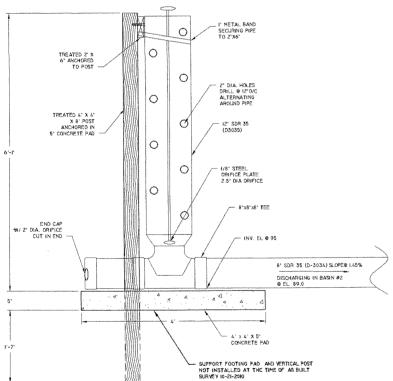
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220 1/2 N. Bridge Street P.O. Box 44 Chippewa Falls, WI 54729 Office: (715) 723-6777

Fax: (715) 723-6842 www.tiryengineering.com

Michael J. Tiry P.E. DGB/JCC PROJECT MANAGER:

MJT

DESIGNED:

DRAWN:

-ATTENTION-IF THIS BAR DOES NOT MEASURE 1" THEN DRAWING IS NOT TO SCALE

-SHEET DESCRIPTION-As Built Basin Pipe Detail

-CLIENT-

4-18-11 SHEET 11 OF 11 Ed Herman

DRAWING NO.

HERM-02-09