RIVERSIDE VISTA

IMPROVEMENT PLANS

TOWN OF VERONA, DANE COUNTY, WISCONSIN

SHEET NO.

14

15

16

17





-PROJECT LOCATION

www.DiggersHotline.com

THE LOCATION OF ANY AND ALL EXISTING UTILITIES, INCLUDING UNDERGROUND AND OVERHEAD, SHOWN ON THE PLANS ARE APPROXIMATE. THE CONTRACTOR SHALL BE RESPONSIBLE FOR DETERMINING EXACT LOCATION OF ANY UTILITIES, WHETHER DEPICTED ON THE PLANS OR NOT, BEFORE COMMENCING WORK. THE CONTRACTOR SHALL BE RESPONSIBLE FOR ANY AND ALL DAMAGES THAT ARISE BY THE CONTRACTOR'S FAILURE TO EXACTLY LOCATE AND PROTECT ANY AND ALL UTILITIES.



ı		IIILE SHEET				
2		GENERAL NOTES AND LEGENDS				
3		EXISTING CONDITIONS PLAN				
4		SITE PLAN				
5		OVERALL GRADING AND EROSION CONTROL PLAN				
6		INTERSECTION, CUL-DE-SAC & STORMWATER AREA GRADING PLAN				
7	STA 0+00 - 5+50	PLAN AND PROFILE — RIVERSIDE VISTA WAY				
8	STA 5+50 - 11+00	PLAN AND PROFILE — RIVERSIDE VISTA WAY				
9	STA 20+00 - 25+00	PLAN AND PROFILE — STORMWATER BASINS				
10	STA 1+00 - 5+00	CROSS SECTIONS				
11	STA 5+50 - 8+00	CROSS SECTIONS				
12	STA 8+50 - 9+50	CROSS SECTIONS				
13	STA 10+00 - 10+50	CROSS SECTIONS				

DESCRIPTION TITLE SHEET

CONSTRUCTION DETAILS

CONSTRUCTION DETAILS

CONSTRUCTION DETAILS

CONSTRUCTION DETAILS

INDEX

STATIONS



2/5/2024 ALC

230019

RIVERSIDE VISTA

IMPROVEMENT PLANS

TOWN OF VERONA, DANE COUNTY, WISCONSIN





-PROJECT LOCATION

IGGERS HOTLINE®

www.DiggersHotline.com

THE LOCATION OF ANY AND ALL EXISTING UTILITIES, INCLUDING UNDERGROUND AND OVERHEAD, SHOWN ON THE PLANS ARE APPROXIMATE. THE CONTRACTOR SHALL BE RESPONSIBLE FOR DETERMINING EXACT LOCATION OF ANY UTILITIES, WHETHER DEPICTED ON THE PLANS OR NOT, BEFORE COMMENCING WORK. THE CONTRACTOR SHALL BE RESPONSIBLE FOR ANY AND ALL DAMAGES THAT ARISE BY THE CONTRACTOR'S FAILURE TO EXACTLY LOCATE AND PROTECT ANY AND ALL UTILITIES.



Digitally signed by Adam Carrico
DN: cn-Adam Carrico, c-US, o-Carrico
Engineering,
enall-adam@carricoengineering.com
Reason: I am the author of this
document
Date: 2024.02.04 23:31:13-0600

INDEX

SHEET NO.	STATIONS	DESCRIPTION			
1		TITLE SHEET			
2		GENERAL NOTES AND LEGENDS			
3		EXISTING CONDITIONS PLAN			
4		SITE PLAN			
5		OVERALL GRADING AND EROSION CONTROL PLAN			
6		INTERSECTION, CUL—DE—SAC & STORMWATER AREA GRADING PLAN			
7	STA 0+00 - 5+50	PLAN AND PROFILE — RIVERSIDE VISTA WAY			
8	STA 5+50 - 11+00	PLAN AND PROFILE - RIVERSIDE VISTA WAY			
9	STA 20+00 - 25+00	PLAN AND PROFILE — STORMWATER BASINS			
10	STA 1+00 - 5+00	CROSS SECTIONS			
11	STA 5+50 - 8+00	CROSS SECTIONS			
12	STA 8+50 - 9+50	CROSS SECTIONS			
13	STA 10+00 - 10+50	CROSS SECTIONS			
14		CONSTRUCTION DETAILS			
15		CONSTRUCTION DETAILS			
16		CONSTRUCTION DETAILS			
17		CONSTRUCTION DETAILS			



Title Sheet
Riverside Vista
Town of Verona

Revisions	Description		
Ř	Date		
	No.		
Revisions	Description		
Re	Date		
	No.		

2/5/2024

ALC
oject No:
230019
eet No:
1 of 17

PROJECT INFORMATION

AGENCIES:

TOWN OF VERONA 7669 COUNTY HIGHWAY PD VERONA, WI 53593 (608) 845-7187

DANE COUNTY LAND & WATER RESOURCES 5201 FEN OAK DR MADISON, WI 53718 (608) 224-3730

EMERGENCY - FIRE, RESCUE, AMBULANCE, POLICE **DIAL 911**

VERONA FIRE DEPARTMENT 101 LINCOLN ST VERONA WI 53593 (608) 845-9401

DANE COUNTY SHERIFF 115 W DOTY ST MADISON, WI 53703 (608) 266-4948

UTILITIES:

ELECTRIC COMPANY ALLIANT ENERGY KRYSTAL MCDERMOTT (608) 842-1741

TELEPHONE/INTERNET TDS TELECOM JERRY MYERS (608) 664-4404

TOPOGRAPHIC SYMBOL & LINEWORK LEGEND

FOUND 1" Ø IRON PIPE

SET P.K. NAIL / CONTROL POINT

EXISTING TELEPHONE PEDESTAL

EXISTING BURIED TELEPHONE LINE

EXISTING CONIFEROUS TREE

EXISTING DECIDUOUS TREE EXISTING BORING LOCATION

EXISTING STORM PIPE

EXISTING EDGE OF TREES

EXISTING MINOR CONTOUR

EXISTING ASPHALT PAVEMENT

EXISTING ELECTRICAL TRANSFORMER

BENCHMARK

EXISTING POST

EXISTING SIGN

* * * EXISTING GENERAL FENCE

— -1115 - EXISTING MAJOR CONTOUR

GAS LINE EXISTING GAS LINE

--- 1114---

NATURAL GAS MADISON GAS & ELECTRIC JOHN WICHERN (608) 252-1563

OWNER:

COONS CONSTRCUTION OF VERONA VERONA, WI

ENGINEER:

CARRICO ENGINEERING 8177 COUNTY ROAD G VERONA, WI 53593 (608) 832-6352

SURVEYOR:


WILLIAMSON SURVEYING & ASSOCIATES, LLC. 104A WEST MAIN ST WAUNAKEE, WI 53597 (608) 255-5705


GENERAL NOTES

- TOPOGRAPHIC SURVEY AND UTILITIES SHOWN ARE FROM SURVEY PREVIOUSLY COMPLETED BY OTHERS COMBINED WITH GIS LIDAR
- 2. CONTRACTOR SHALL FIELD VERIFY ALL EXISTING CONDITIONS PRIOR TO COMMENCING WORK AND DISCREPANCIES SHALL BE REPORTED TO THE ENGINEER PRIOR TO STARTING WORK.
- CONTRACTOR SHALL KEEP ADJACENT ROADS AND PRIVATE PROPERTY FREE AND CLEAR OF CONSTRUCTION RELATED EQUIPMENT, DIRT, DUST AND DEBRIS.
- 4. CONTRACTOR SHALL BE RESPONSIBLE FOR COORDINATING THE RELOCATION OR GRADING AROUND ANY EXISTING UTILITY LINES AND UTILITY PEDESTALS WITH UTILITY COMPANIES PRIOR TO BEGINNING CONSTRUCTION.
- 5. ALL SAWCUTTING SHALL BE FULL DEPTH TO PROVIDE A CLEAN EDGE TO MATCH NEW PAVEMENT ROAD ENDS AND DRIVEWAYS.
- CONTRACTOR SHALL BE RESPONSIBLE FOR ANY NECESSARY TRAFFIC CONTROL AND SAFETY MEASURES DURING CONSTRUCTION.

- ALL TREES REQUIRED TO BE REMOVED SHALL BE REMOVED IN THEIR ENTIRETY AND STUMPS SHALL BE GROUND TO PROPOSED SUBGRADE OR AT LEAST 4" BELOW FINISHED GRADE WHERE NOT IN ROAD BED AREA. CONTRACTOR TO COORDINATE WITH LANDOWNER PRIOR TO ANY REMOVALS.
- CONTRACTOR SHALL PROVIDE TREE PROTECTION FENCING PRIOR TO CONSTRUCTION FOR ANY TREES REMAINING THAT ARE NEAR DISTURBANCE LIMITS. MAINTAIN FENCING THROUGHOUT CONSTRUCTION. TREE PROTECTION FENCING SHALL BE EITHER CHAIN LINK FENCE SECTIONS THAT ARE INSTALLED ON GRADE WITH "FEET" OR WOOD OR PLASTIC SNOW FENCE.
- TREE PROTECTION SHALL BE REQUIRED WHENEVER THERE WILL BE CONSTRUCTION ACTIVITY THAT COULD RESULT IN DISTURBANCE WITHIN THE CRITICAL ROOT RADIUS OF A TREE THAT IS TO BE SAVED OR WHENEVER THERE IS THE POTENTIAL FOR DAMAGE TO BRANCHES OF PLATS THAT ARE TO BE SAVED DURING CONSTRUCTION.
- 10. ALL PROPOSED STORM SEWER LENGTHS ON PLANS INCLUDE ENDWALL IN LENGTH WHERE ENDWALL IS CALLED OUT

LEGENDS

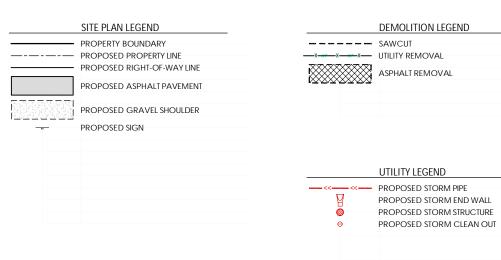


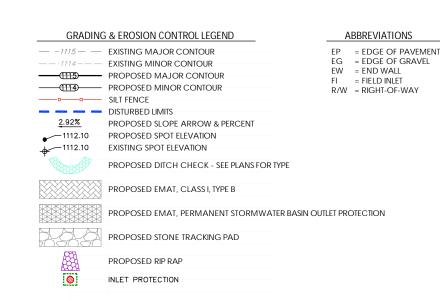



Engineering arrice


Notes and Legends General


AS SHOWN 2/5/2024 ALC roiect No:

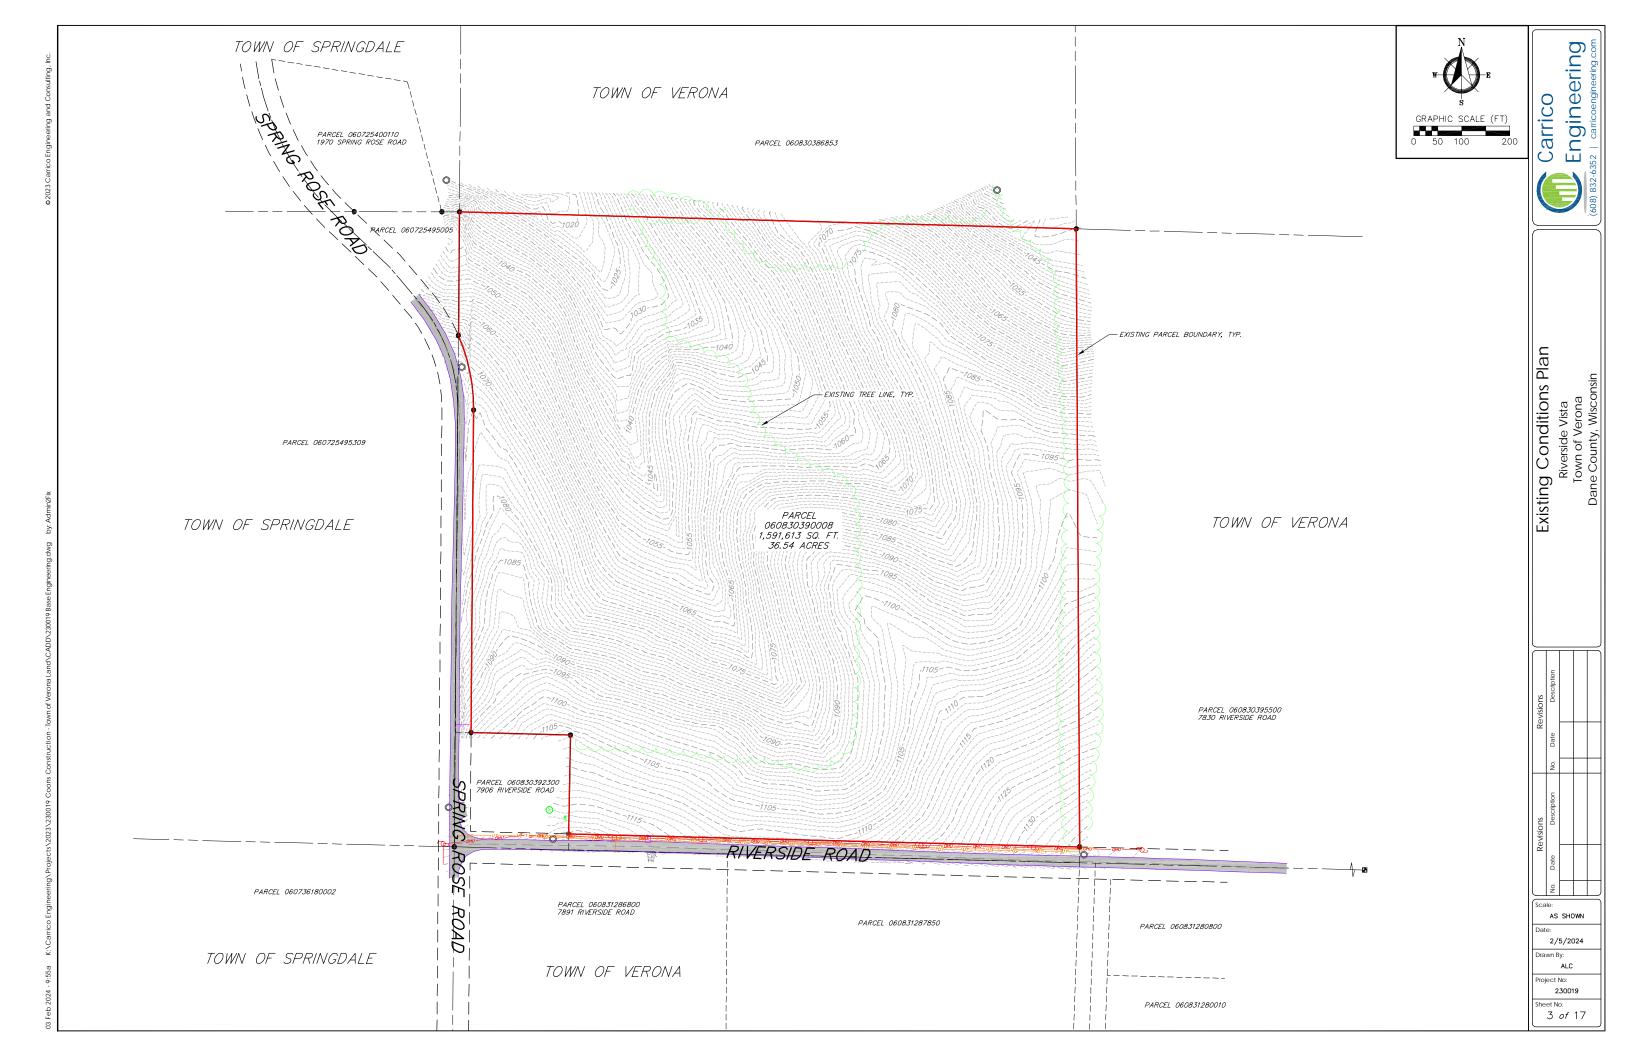


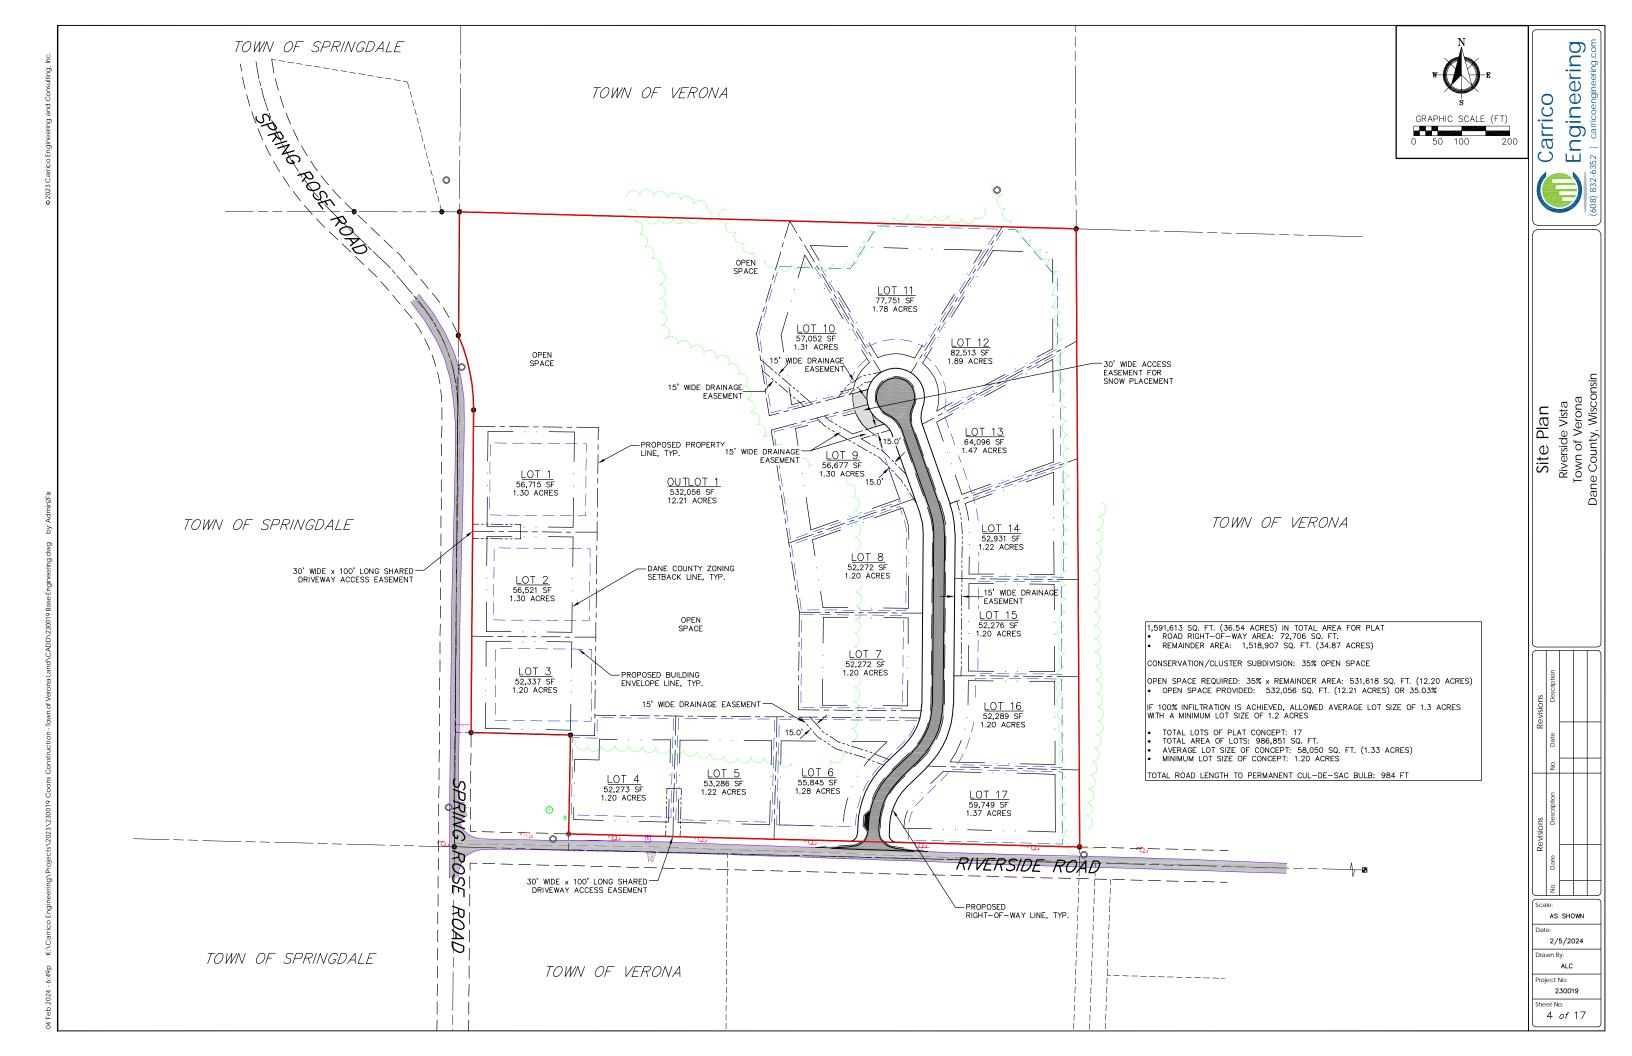


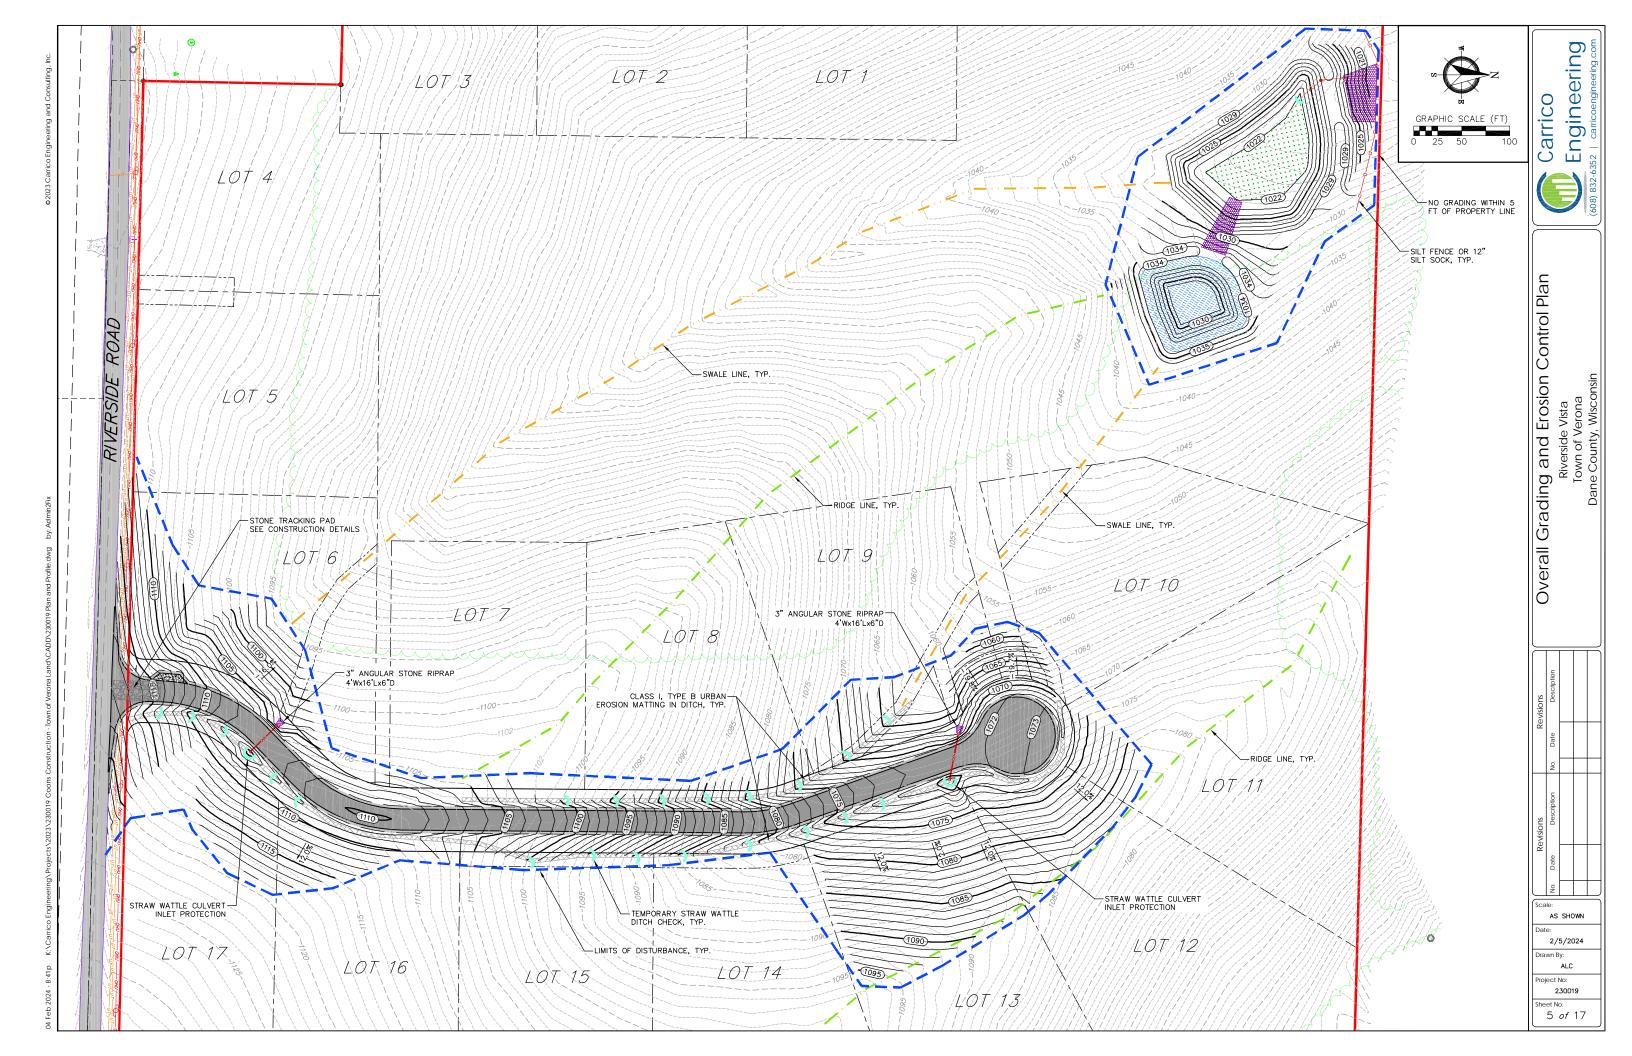

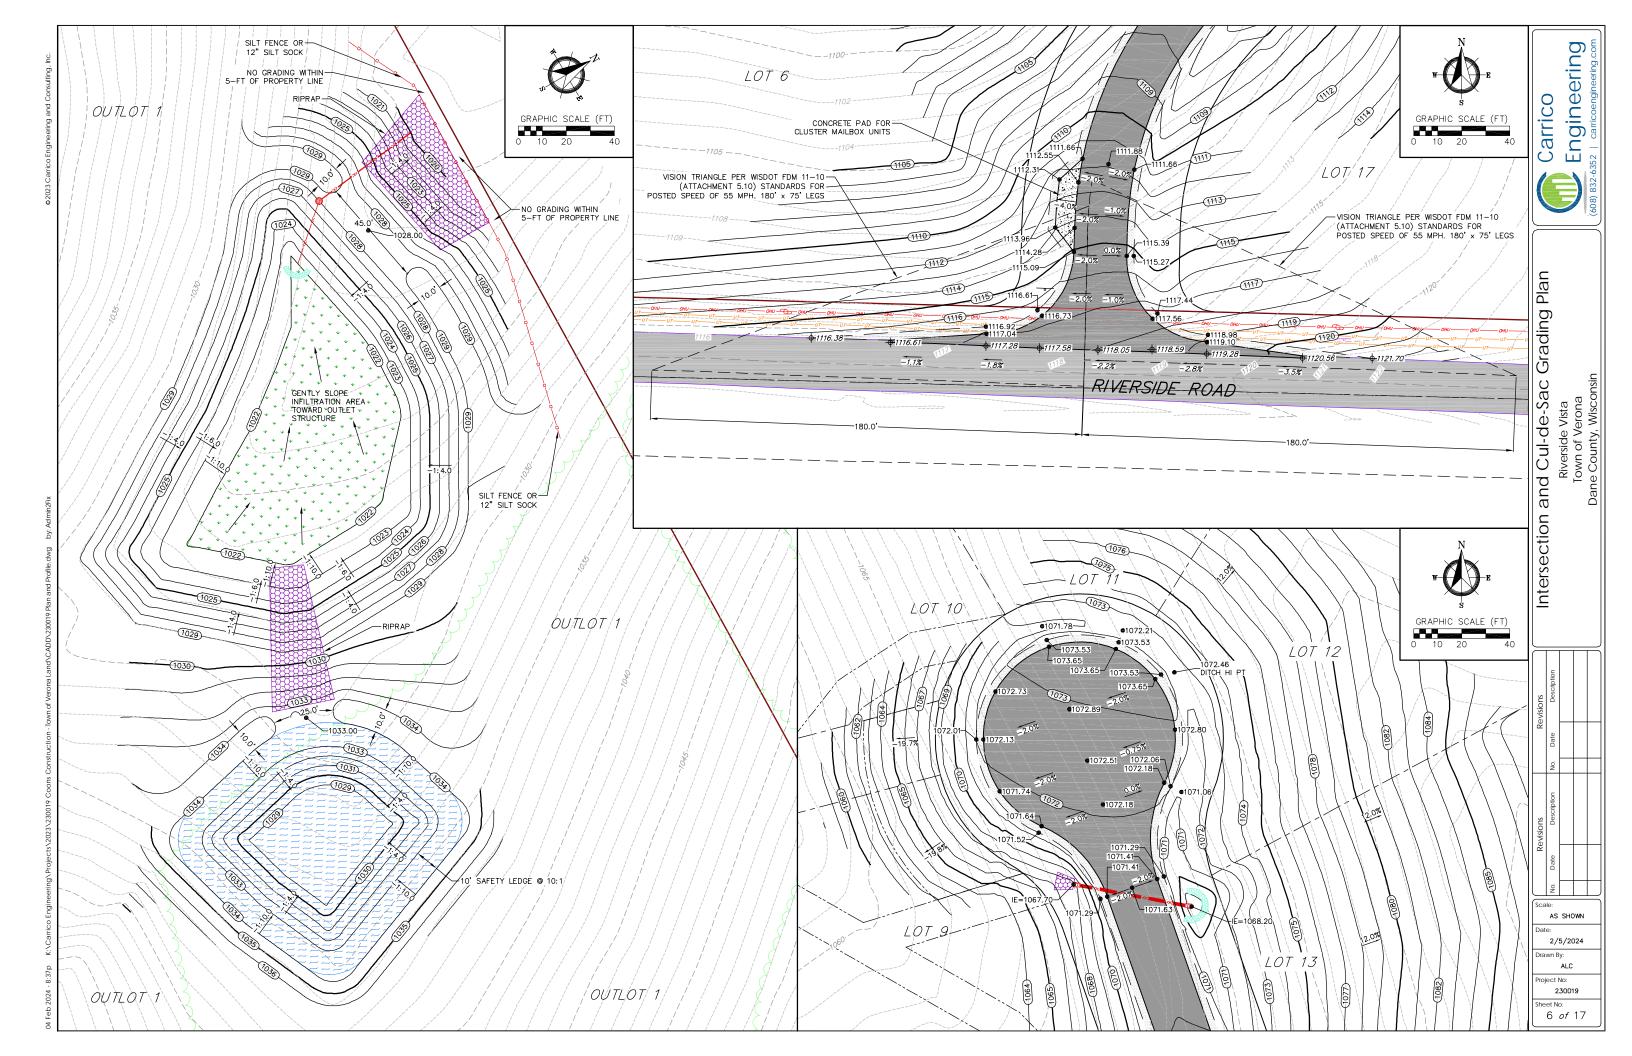

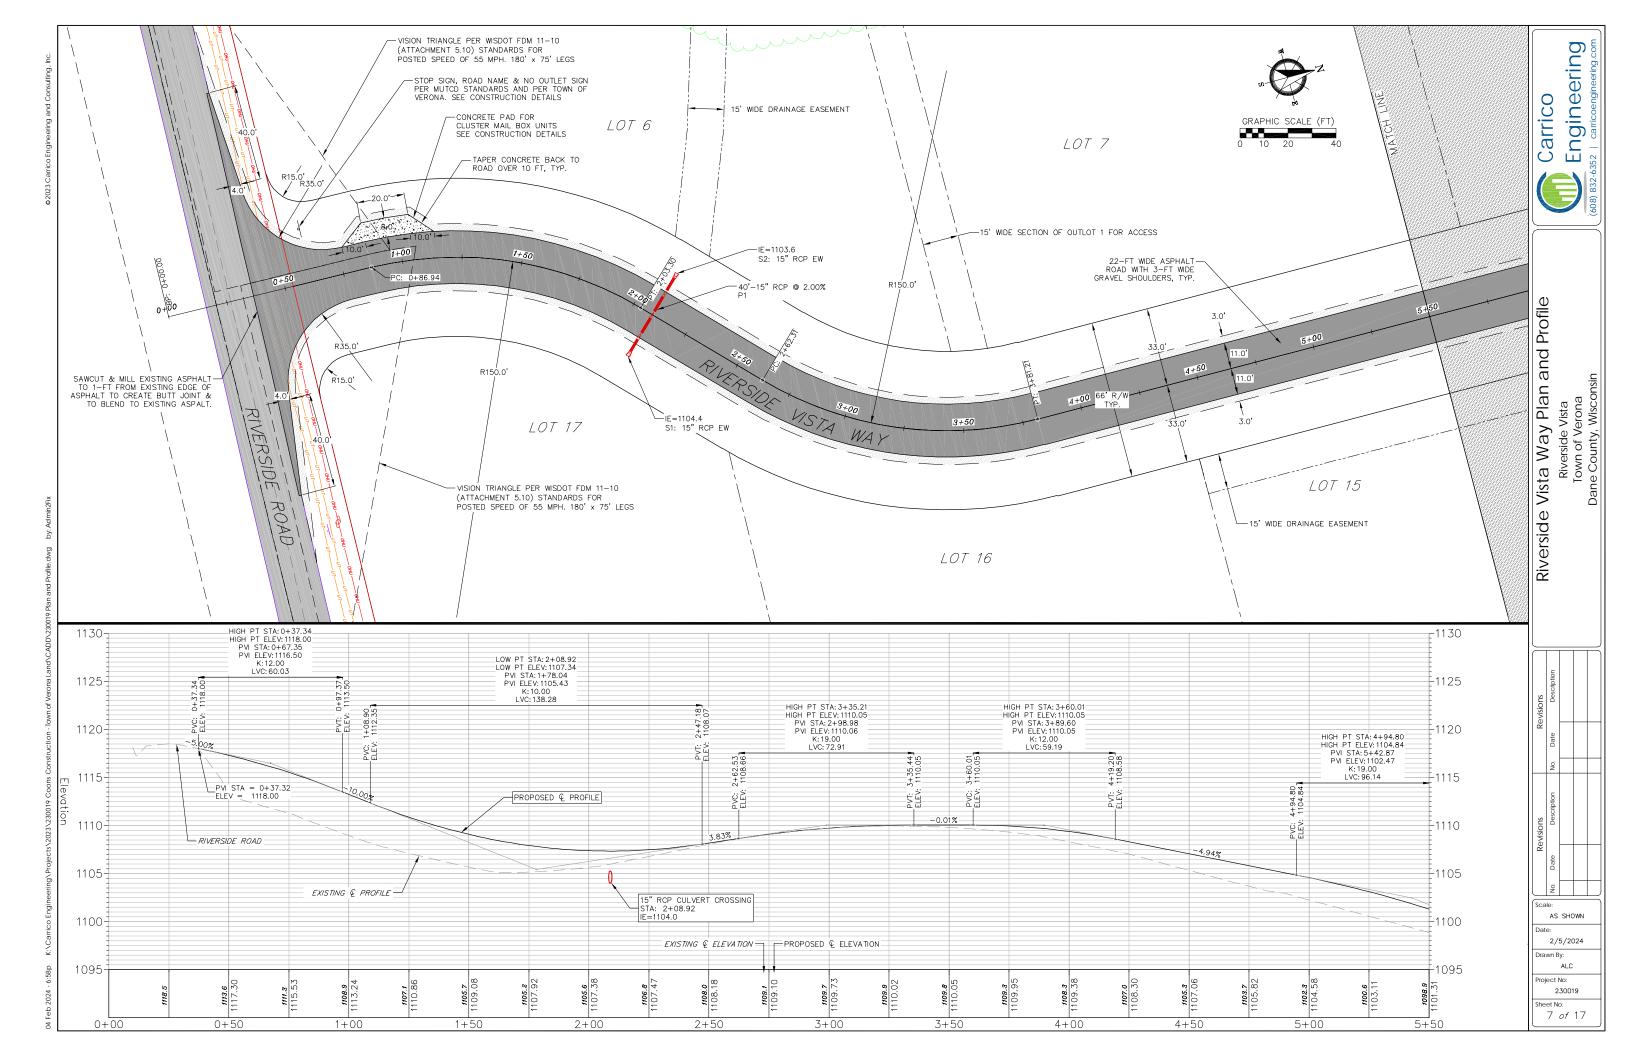

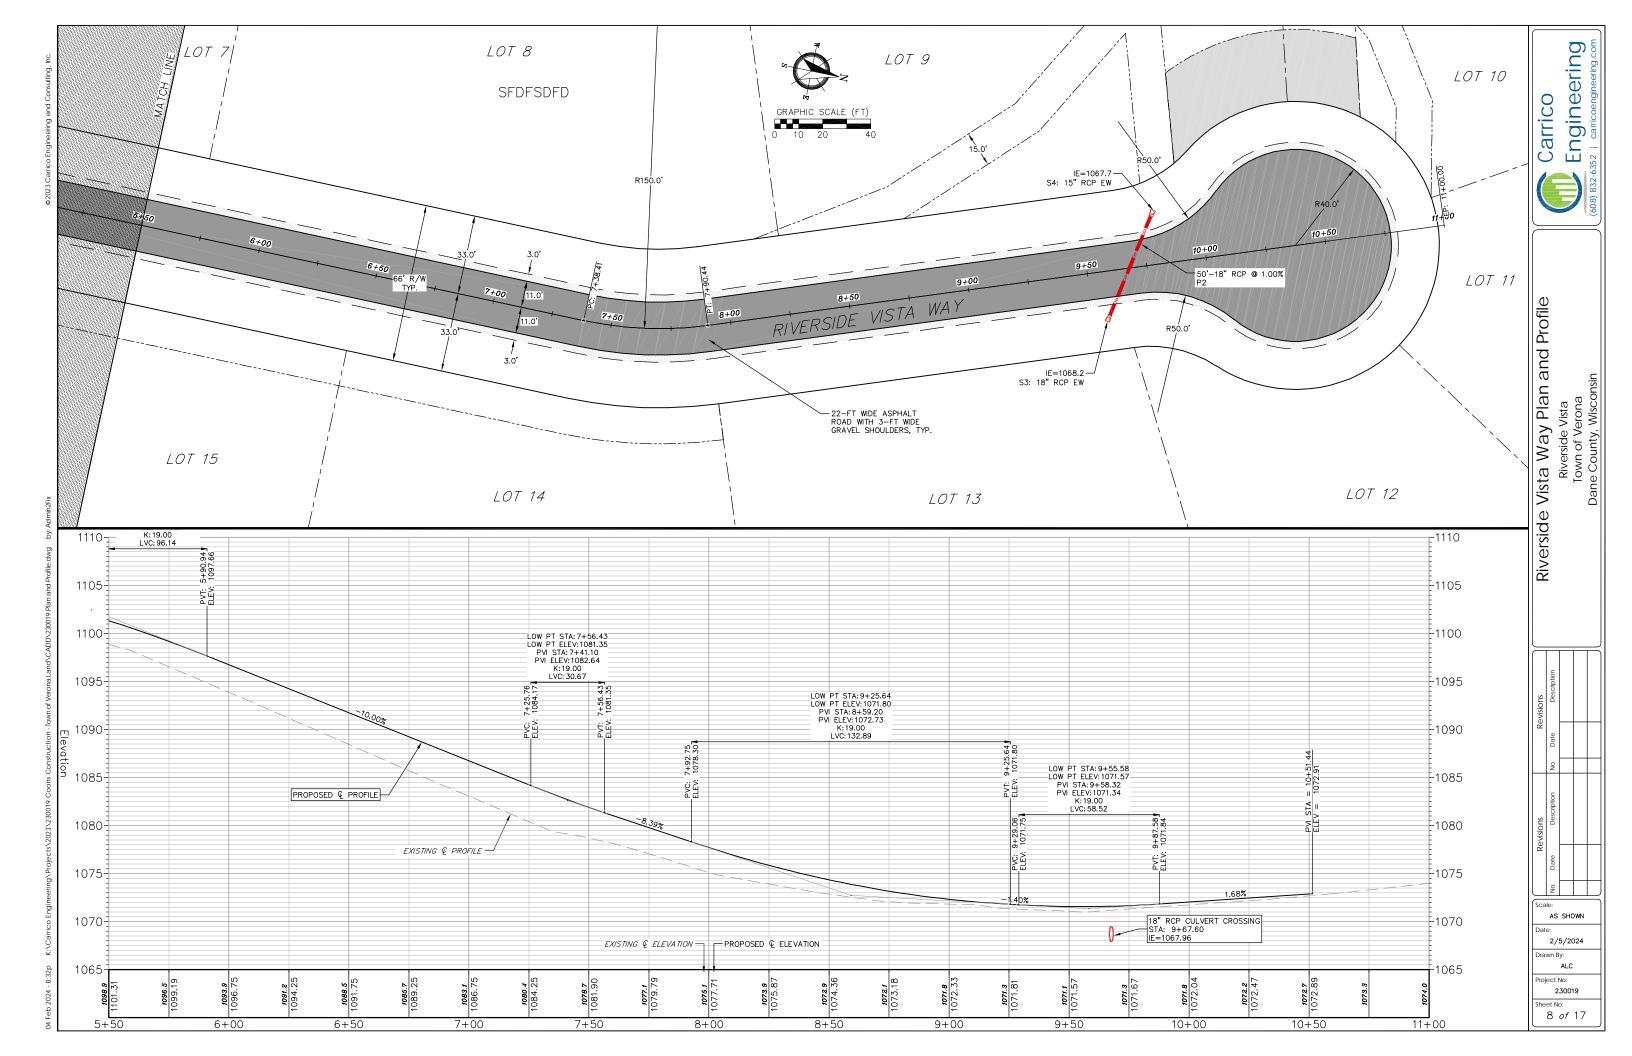

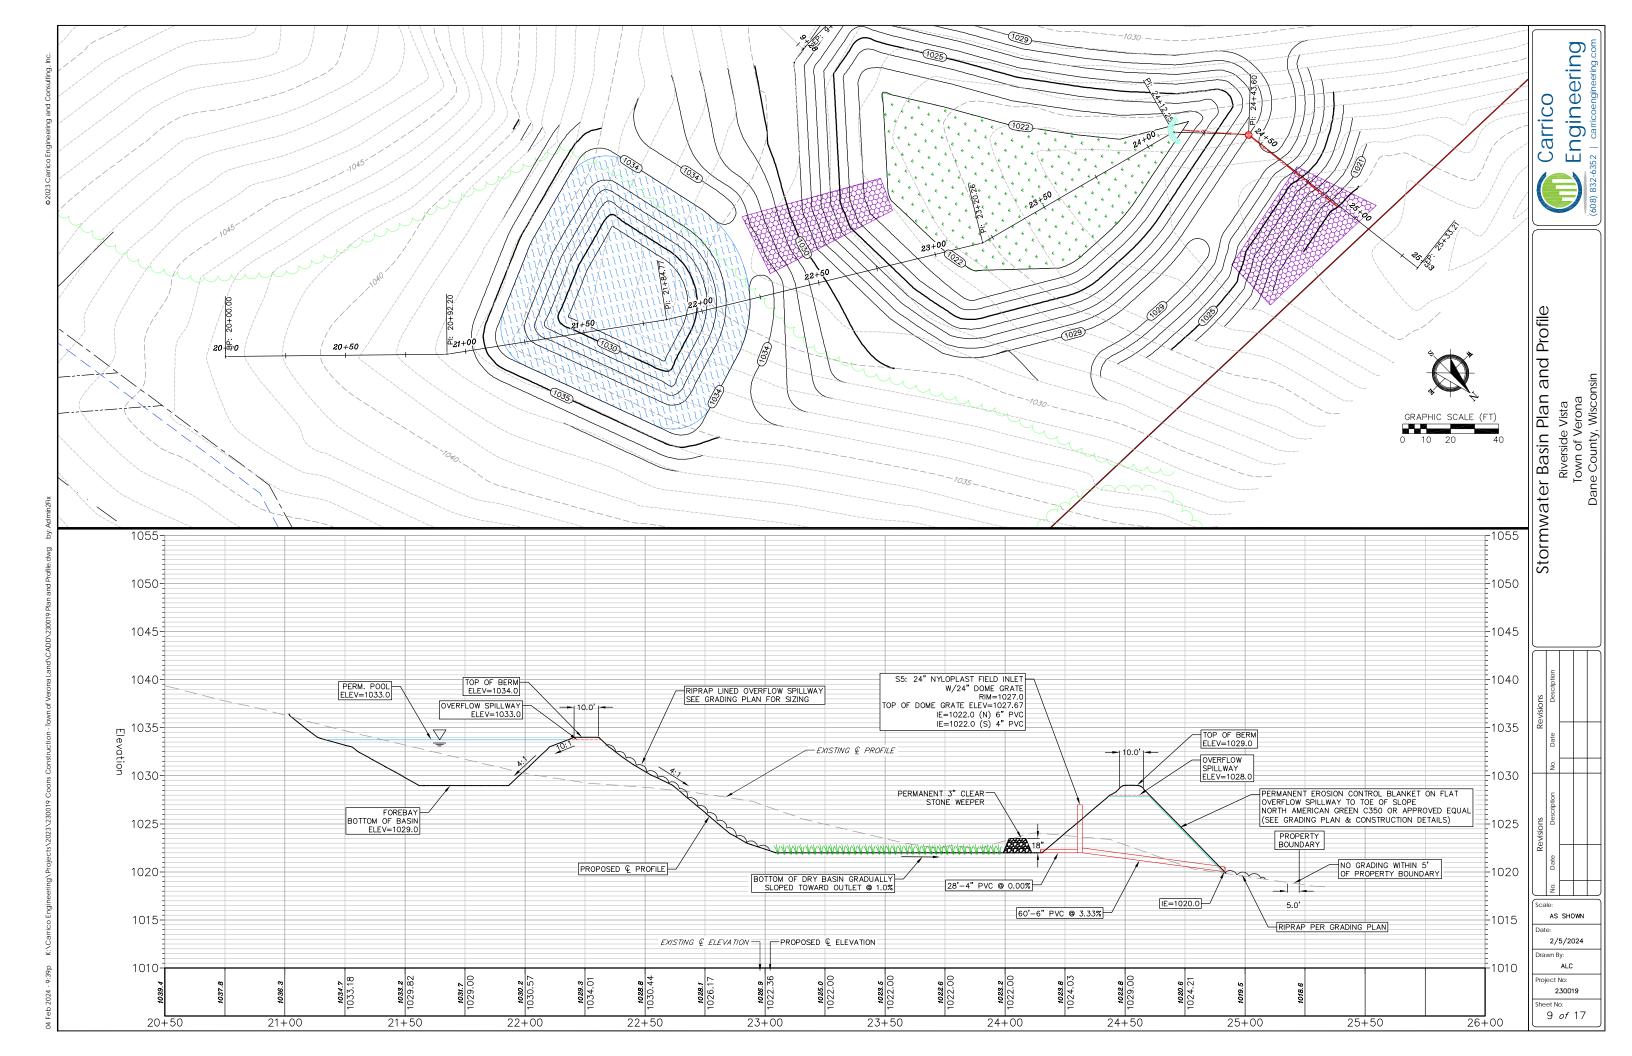

Cross Sections - Riverside Vista Way
Riverside Vista
Town of Verona
Dane County, Wisconsin

Engineering

Carrico

1092

1112

AS SHOWN 2/5/2024 ALC roiect No: 230019

heet No:

10 of 17

1" = 20' HORIZ. (24"x36") 1" - 10' VEDT (24"x36") 1" = 40' HORIZ. (11"x17") 1" - 20' \/FDT (11"v17"\

3+00.00

1112

1104

1" = 20' HORIZ. (24"x36") 1" = 10' VERT. (24"x36")

1" = 40' HORIZ. (11"x17") 1" = 20' VERT. (11"x17")



Cross Sections - Riverside Vista Way
Riverside Vista
Town of Verona
Dane County, Wisconsin

AS SHOWN

2/5/2024

ALC

Project No: Sheet No: 11 of 17

1072 -7+50.00 R/W OFF: -33.0 ELEV: 1084.7 R/W OFF: 33.0 ELEV: 1083.2 7+00.00 R/W OFF: -33.0 ELEV: 1090.3 - 1104 R/W OFF: 33.0 ELEV: 1087.4 2.0% 1082 80 1084 -1082 -6+50.00 - 1112 R/W OFF: -33.0 ELEV: 1095.7 R/W OFF: 33.0 ELEV: 1092.9 6+00.00

R/W OFF: -33.0 ELEV: 1079.4

R/W OFF: -33.0 ELEV: 1100.3

R/W OFF: 33.0 ELEV: 1080.9


R/W OFF: 33.0 ELEV: 1098.0


2.0% 2.0%


5+50.00

R/W OFF: 33.0 ELEV: 1077.9 R/W OFF: -33.0 ELEV: 1075.4 8+00.00

Cross Sections - Riverside Vista Way
Riverside Vista
Town of Verona
Dane County, Wisconsin

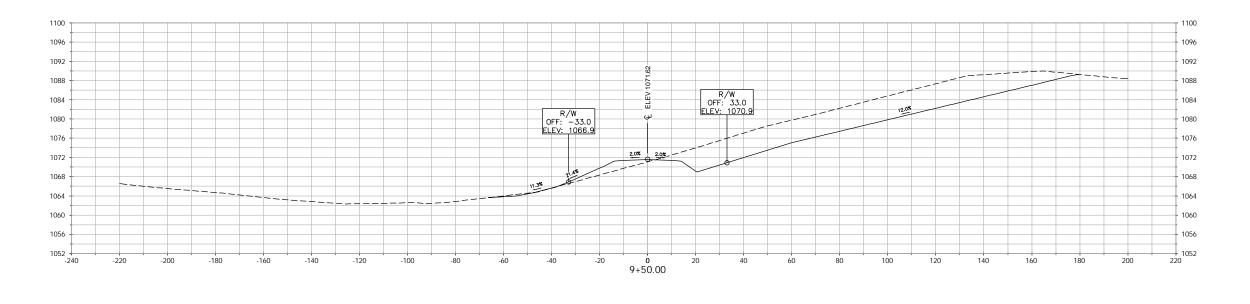

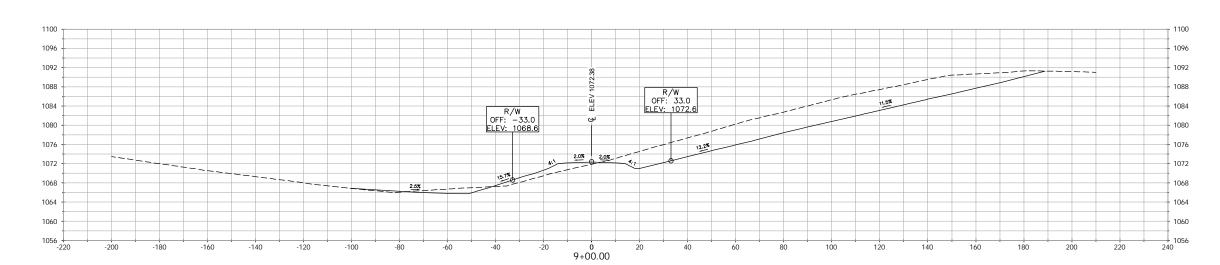

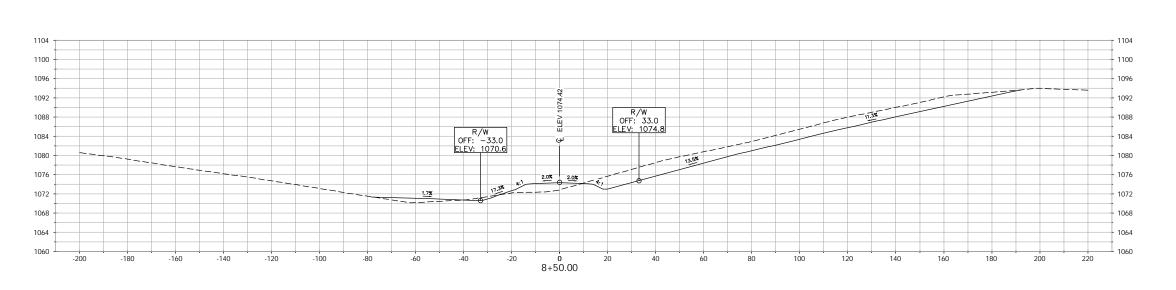

AS SHOWN

2/5/2024

ALC

12 of 17


Project No: 230019

1" = 40' HORIZ. (11"x17") 1" - 20' \/FDT /11"v17"\

1" = 20' HORIZ. (24"x36") 1" = 10' \/FDT (24"\24"\



R/W OFF: 58.7 ELEV: 1073.7 R/W OFF: -58.7 ELEV: 1068.5 -140 10+50.00

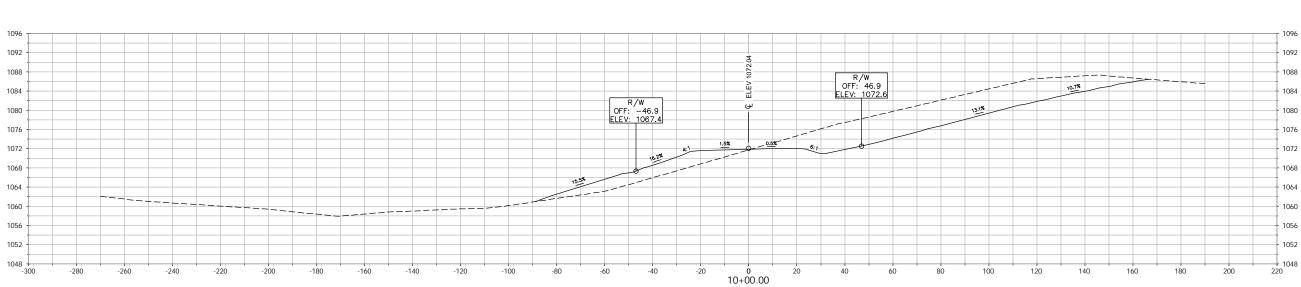

AS SHOWN 2/5/2024 ALC

> Project No:

13 of 17

1" = 20' HORIZ. (24"x36") 1" - 10' \/EDT /24"v26"\

1" = 40' HORIZ. (11"x17") 1" - 20' \/FDT /11"v17"\

SEEDING RATES:

LB./1,000 S.F.

MULCHING RATES:

TEMPORARY AND PERMANENT:

LB./1,000 S.F.

FERTILIZING RATES:

USE ANNUAL OATS AT 3.0 LB./1,000 S.F. FOR SPRING AND SUMMER PLANTINGS.

2. USE WINTER WHEAT OR RYE AT 3.0

LB./1,000 SF FOR FALL PLANTINGS STARTED AFTER SEPTEMBER 15.

3. SEE DRY DETENTION BASIN DETAIL FOR

SEEDING OF DRY DETENTION BASINS.

TEMPORARY AND PERMANENT: USE WISCONSIN D.O.T. TYPE A OR B AT 7

USE ½" TO 1-½" STRAW OR HAY MULCH, CRIMPED PER SECTION 607.3.2.3, OR OTHER

WISCONSIN D.O.T. STANDARD SPECIFICATIONS

FOR HIGHWAY AND STRUCTURE CONSTRUCTION

RATE AND METHOD PER SECTION 627,

PERMANENT:
1. USE WISCONSIN D.O.T. SEED MIX #40 AT 2


EROSION CONTROL MEASURES

- EROSION CONTROL SHALL BE IN ACCORDANCE WITH THE TOWN OF VERONA EROSION CONTROL ORDINANCE, CHAPTER 11 AND 14 OF THE DANE COUNTY ORDINANCES AND CHAPTER NR 216 OF THE WISCONSIN ADMINISTRATIVE CODE.
- 2. CONSTRUCT AND MAINTAIN ALL EROSION AND SEDIMENT CONTROL MEASURES IN ACCORDANCE WITH WISCONSIN DNR TECHNICAL STANDARDS (http://dnr.wi.gov/runoff/stormwater/techstds.htm) AND WISCONSIN CONSTRUCTION SITE BEST MANAGEMENT PRACTICE HANDBOOK
- 3. INSTALL SEDIMENT CONTROL PRACTICES (TRACKING PAD, PERIMETER SILT FENCE, SEDIMENT BASINS, ETC.) PRIOR TO INITIATING OTHER LAND DISTURBING CONSTRUCTION ACTIVITIES.
- 4. THE CONTRACTOR IS REQUIRED TO MAKE EROSION CONTROL INSPECTIONS AT THE END OF EACH WEEK AND WHEN 0.5 INCHES OF RAIN FALLS WITHIN 24 HOURS. INSPECTION REPORTS SHALL BE PREPARED AND FILED AS REQUIRED BY THE DNR AND/OR THE TOWN OF VERONA. ALL MAINTENANCE WILL FOLLOW AN INSPECTION WITHIN 24 HOURS.
- 5. FROSION CONTROL IS THE RESPONSIBILITY OF THE CONTRACTOR UNTIL ACCEPTANCE OF THIS PROJECT. EROSION CONTROL MEASURES AS SHOWN SHALL BE THE MINIMUM PRECAUTIONS THAT WILL BE ALLOWED. ADDITIONAL EROSION CONTROL MEASURES, AS REQUESTED IN WRITING BY THE STATE OR LOCAL INSPECTORS, OR THE DEVELOPER'S ENGINEER, SHALL BE INSTALLED WITHIN 24 HOURS.
- 6 A 3" CLEAR STONE TRACKING PAD SHALL BE INSTALLED AT THE FND OF ROAD CONSTRUCTION LIMITS TO PREVENT SEDIMENT FROM BEING TRACKED ONTO THE ADJACENT PAVED PUBLIC ROADWAY. SEDIMENT TRACKING PAD SHALL CONFORM TO WISDNR TECHNICAL STANDARD 1057. SEDIMENT REACHING THE PUBLIC ROAD SHALL BE REMOVED BY STREET CLEANING (NOT HYDRAULIC FLUSHING) BEFORE THE END OF EACH WORK DAY.
- 7. CHANNELIZED RUNOFF: FROM ADJACENT AREAS PASSING THROUGH THE SITE SHALL BE DIVERTED AROUND DISTURBED AREAS IF POSSIBLE.
- 8. STABILIZED DISTURBED GROUND: ANY SOIL OR DIRT PILES WHICH WILL REMAIN IN EXISTENCE FOR MORE THAN 7-CONSECUTIVE DAYS, WHETHER TO BE WORKED DURING THAT PERIOD OR NOT, SHALL NOT BE LOCATED WITHIN 25-FEET OF ANY ROADWAY, PARKING LOT, PAVED AREA, OR DRAINAGE STRUCTURE OR CHANNEL (UNLESS INTENDED TO BE USED AS PART OF THE EROSION CONTROL MEASURES). TEMPORARY STABILIZATION AND CONTROL MEASURES (SEEDING, MULCHING, TARPING, EROSION MATTING, BARRIER FENCING, ETC.) ARE REQUIRED FOR THE PROTECTION OF DISTURBED AREAS AND SOIL PILES, WHICH WILL REMAIN UN-WORKED FOR A PERIOD OF MORE THAN 14-CONSECUTIVE CALENDAR DAYS. THESE MEASURES SHALL REMAIN IN PLACE UNTIL SITE HAS STABILIZED.
- 9. IMMEDIATELY STABILIZE STOCKPILES AND SURROUND STOCKPILES AS NEEDED WITH SILT FENCE OR OTHER PERIMETER CONTROL IF STOCKPILES WILL REMAIN INACTIVE FOR 7 DAYS
- 10. SITE DE-WATERING: WATER PUMPED FROM THE SITE SHALL BE TREATED BY TEMPORARY SEDIMENTATION BASINS OR OTHER APPROPRIATE CONTROL MEASURES. SEDIMENTATION BASINS SHALL HAVE A DEPTH OF AT LEAST 3 FEET, BE SURROUNDED BY SNOWFENCE OR EQUIVALENT BARRIER AND HAVE SUFFICIENT SURFACE AREA TO PROVIDE A SURFACE SETTLING RATE OF NO MORE THAN 750 GALLONS PER SQUARE FOOT PER DAY AT THE HIGHEST DEWATERING PUMPING RATE. WATER MAY NOT BE DISCHARGED IN A MANNER THAT CAUSES EROSION OF THE SITE, A NEIGHBORING SITE, OR THE BED OR BANKS OF THE RECEIVING WATER. POLYMERS MAY BE USED AS DIRECTED BY DNR TECHNICAL STANDARD 1061 (DE-WATERING).
- 11. SEE DETAIL SHEETS AND GRADING AND EROSION CONTROL PLAN FOR RIP-RAP SIZING. IN NO CASE WILL RIP-RAP BE SMALLER THAN 3" TO 6".
- 12. USE DETENTION BASINS AS SEDIMENT BASINS DURING CONSTRUCTION (DO NOT USE INFILTRATION AREAS). AT THE END OF CONSTRUCTION, REMOVE SEDIMENT AND RESTORE PER
- 13. RESTORATION (SEED, FERTILIZE AND MULCH/MATTING) SHALL BE PER SPECIFICATIONS ON THIS SHEET UNLESS SPECIAL RESTORATION IS CALLED FOR ON THE DETENTION BASIN DETAIL SHEET
- 14. AFTER DETENTION BASIN GRADING IS COMPLETE, THE BOTTOM OF DRY BASINS SHALL RECEIVE 6" TOPSOIL AND SHALL BE CHISEL-PLOWED TO A MINIMUM DEPTH OF 12" PRIOR TO
- 15. SEED, FERTILIZER AND MULCH/MATTING SHALL BE APPLIED WITHIN 7 DAYS AFTER FINAL GRADE HAS BEEN ESTABLISHED. IF DISTURBED AREAS WILL NOT BE RESTORED. IMMEDIATELY AFTER ROUGH GRADING, TEMPORARY SEED SHALL BE PLACED
- 16. FOR THE FIRST SIX WEEKS AFTER RESTORATION (E.G. SEED & MULCH, EROSION MAT) OF A DISTURBED AREA, INCLUDE SUMMER WATERING PROVISIONS OF ALL NEWLY SEEDED AND MULCHED AREAS WHENEVER 7 DAYS ELAPSE WITHOUT A RAIN EVENT.
- 17. SEDIMENT SHALL BE CLEANED FROM DITCHES IF ACCUMULATED AFTER EACH RAINFALL AND PRIOR TO PROJECT ACCEPTANCE.
- 18. ACCUMULATED CONSTRUCTION SEDIMENT SHALL BE REMOVED FROM ALL PERMANENT BASINS TO THE ELEVATION SHOWN ON THE GRADING PLAN FOLLOWING THE STABILIZATION OF DRAINAGE AREAS.
- 19. ALL CONSTRUCTION ENTRANCES SHALL HAVE TEMPORARY ROAD CLOSED SIGNS THAT WILL BE IN PLACE WHEN THE ENTRANCE IS NOT IN USE AND AT THE END OF EACH DAY.
- 20. ANY PROPOSED CHANGES TO THE EROSION CONTROL PLAN MUST BE SUBMITTED AND APPROVED BY DANE COUNTY WATER RESOURCES ENGINEERING OR PERMITTING MUNICIPALITY.
- 21. THE TOWN OF VERONA, DANE COUNTY, OWNER AND/OR ENGINEER MAY REQUIRE ADDITIONAL EROSION CONTROL MEASURES AT ANY TIME DURING CONSTRUCTION
- 22, NO GRADING SHALL BE ALLOWED WITHIN 5 FEET OF A PROPERTY LINE UNLESS AUTHORIZED BY PERMITTING AUTHORITY

CONSTRUCTION SEQUENCE:

- 1. INSTALL SILT FENCE AND TRACKING PAD
- 2. CLEAR AND GRUB AREA FOR STORMWATER BASINS
- 3. STRIP TOPSOIL STORMWATER AREA
- 4. ROUGH GRADE STORMWATER AREA
- 5. STRIP TOPSOIL-ROADS, DITCHES & OTHER DISTURBED AREAS
- 6. ROUGH GRADE-ROADS, DITCHES & OTHER DISTURBED AREAS
- 7. CONSTRUCT ROAD CULVERTS
- 8. CONSTRUCT UNDERGROUND UTILITIES
- 9. PLACE AGGREGATE ON ROADS & COMPACT
- 10. FINAL GRADING
- 11. RESPREAD TOPSOIL
- 12. DEEP TILL-DISTURBED AREAS*
- 13. SEED, FERTILIZE, MULCH/MATTING PER PLAN
- 14. TOUCH UP ROAD AGGREGATE & COMPACT PRIOR TO ASPHALT CONSTRUCTION
- 15. ASPHALT CONSTRUCTION
- 16. FINAL SHOULDERING AND RESTORATION
- 17. EROSION CONTROL FEATURES AFTER DISTURBED AREAS ARE STABILIZED/VEGETATED


*SEE DETAIL 6/SHEET 16 FOR DEEP TILLING DETAIL & NOTES

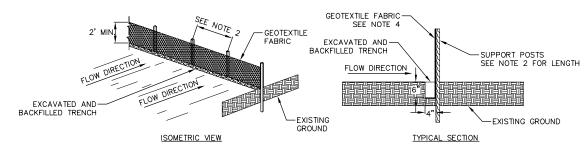

NOTES:

- 1. THE GEOTEXTILE FABRIC SHALL BE PLACED IN THE EXCAVATED TRENCH, BACKFILLED AND COMPACTED TO THE EXISTING GROUND SURFACE.
- 2. TRENCH SHALL BE A MINIMUM OF 4" WIDE AND 6" DEEP TO BURY AND ANCHOR THE GEOTEXTILE FABRIC. FOLD MATERIAL TO FIT TRENCH AND BACKFILL AND COMPACT TRENCH WITH EXCAVATED SOIL
- 3. WOOD POSTS SHALL BE A MINIMUM OF 1-1/8" x 1-1/8" OAK OR HICKORY AND 4 FEET LONG.
- 4. WOOD POST SPACING SHALL BE A MAXIMUM OF 3' FOR NON-WOVEN GEOTEXTILE FABRIC IS USED AND A MAXIMUM OF 8' IF WOVEN GEOTEXTILE FABRIC IS USED.
- 5. THE GEOTEXTILE FABRIC SHALL BE ATTACHED DIRECTLY TO THE UPSLOPE SIDE OF WOODEN POSTS WITH 0.5 INCH STAPLES IN AT LEAST 3
- 6. CONSTRUCT SILT FENCE FROM A CONTINUOUS ROLL IF POSSIBLE BY CUTTING LENGTHS TO AVOID JOINTS. IF A JOINT IS NECESSARY, USE ONE OF THE FOLLOWING TWO METHODS:
- 6.A. TWIST METHOD: OVERLAP THE END POSTS AND TWIST OR ROTATE AT LEAST 180 DEGREES.
 6.B. HOOK METHOD: HOOK THE END OF EACH SILT FENCE LENGTH.



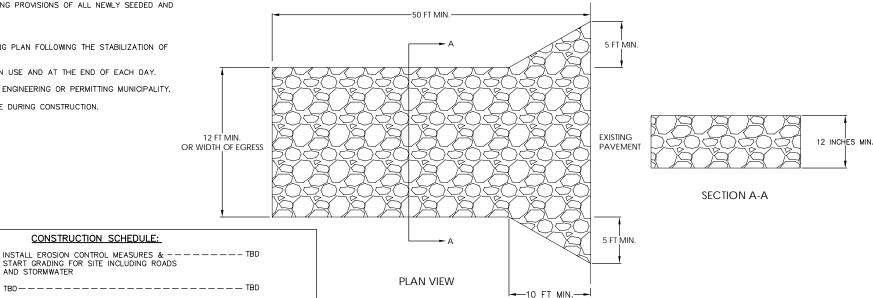

NOTES:

CONSTRUCTION SCHEDULE:

AND STORMWATER

- 1. THE TRACKING PAD SHALL BE INSTALLED PRIOR TO ANY CONSTRUCTION TRAFFIC LEAVING THE SITE
- 2. STONE TRACKING PAD SHALL BE INSTALLED PER WISCONSIN DNR TECHNICAL STANDARD 1057.
- 3. TRACKING PAD SHALL BE A MINIMUM LENGTH OF 50 FEFT, TRACKING PAD SHALL THE FULL WIDTH OF THE EGRESS POINT OR A MINIMUM OF 12 FFFT IN WIDTH TRACKING PAD SHALL BE A MINIMUM DEPTH OF 12 INCHES OF 3 INCH TO 6 INCH CLEAR OR WASHED STONE.
- 4. TRACKING PAD SHALL BE FLARED PER PLAN
- 5. ON SITES WITH A HIGH WATER TABLE, OR WHERE SATURATED CONDITIONS ARE EXPECTED DURING THE LIFE OF THE PRACTICE, STONE TRACKING PADS SHALL BE underlain with a wisconsin dot type r geotextile fabric to prevent migration of underlying soil into the stone
- SURFACE WATER MUST BE PREVENTED FROM PASSING THROUGH THE TRACKING PAD. FLOWS SHALL BE DIVERTED AWAY FROM TRACKING PADS OR CONVEYED



AS SHOW

0

gineerin

ш

arri


onstruction Details


Riverside Vista Town of Verona e County, Wiscor

2/5/2024

ALC

oiect No: 230019

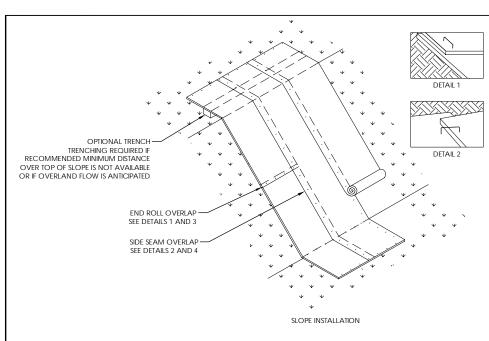


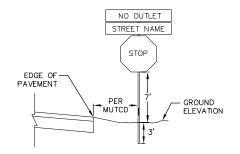

SIGNAGE NOTES:

- ALL SIGNS SHALL BE FABRICATED AND INSTALLED IN ACCORDANCE WITH THE MANUAL ON UNIFORM TRAFFIC CONTROL DEVICES.
 SIGNS SHALL BE A DISTANCE OF 7' FROM GROUND LEVEL TO THE BOTTOM OF THE SIGN
- MOUNTED ON THE POST.
- STREET NAME SIGNS SHALL HAVE WHITE LETTERS AND GREEN BACKGROUND 4. SIGN POSTS SHALL BE 2" GALVANIZED SQUARE TUBE AND 12 FT LONG. MOUNT SIGN AT TOP OF THE POST, AND INSTALL POSTS 3' DEEP AND MIX 1/2 BAG OF 80 LB SAKRETE CONCRETE, POURING IT AROUND THE POST BELOW THE GROUND BEFORE COVERING WITH
- VERIFY AND CONFIRM ALL SIGNS WITH TOWN OF VERONA ENGINEER PRIOR TO PURCHASING AND/OR INSTALLING.



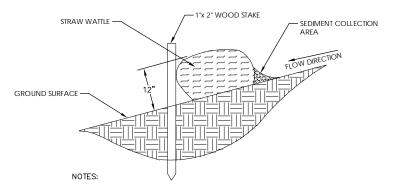


- WATTLES SHALL BE PLACED AS SOON AS GRADING IS DONE SUCH THAT RUNOFF IS ABLE TO BE CONDUCTED OR CONVEYED WITHIN DITCH.
- STAKE DOES NOT NEED TO PIERCE WATTLE, BUT MAY BE DRIVEN AT AN ANGLE TO SECURE WATTLE ALLOWING WATTLE TO BE MOVED AND POSSIBLY


 OFFICE OF THE PROPERTY OF




STRAW WATTLE DETAIL


NOT TO SCALE

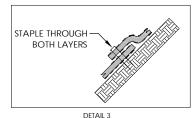


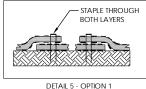

DETAIL 5 - OPTION 1 CHANNEL INSTALLATION

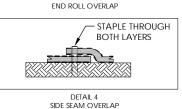


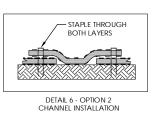


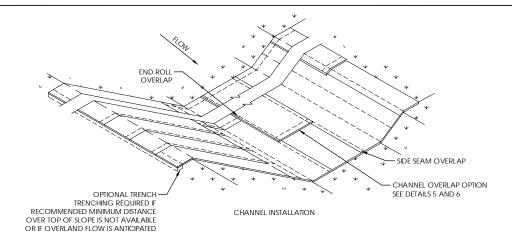


- 1. STAPLE PATTERNS ARE DEPENDENT UPON SLOPE CONDITIONS AND MANUFACTURER'S RECOMMENDATIONS.
- 2. STAPLES OF 11 GAUGE OR HEAVIER SHALL BE USED TO HOLD MATS AND NETS IN PLACE
- STAPLES SHALL BE U-SHAPED WITH A 1-INCH TO 2-INCH CROWN.
- 4. STAPLE LENGTHS ARE DETERMINED BASED ON SOIL CONDITION, BUT SHALL NOT BE LESS THAN 6 INCHES LONG. SEE WDNR TECHNICAL STANDARD 1052 FOR FURTHER LENGTH REQUIREMENTS.
- 5. FOLLOW MANUFACTURER'S RECOMMENDATIONS FOR BOTH END AND EDGE OVERLAP LENGTH.
- 6. CONSIDER THE USE OF BIODEGRADABLE STAPLES IN LOCATIONS WHERE WIRE STAPLES ARE DETERMINED TO BE A RISK



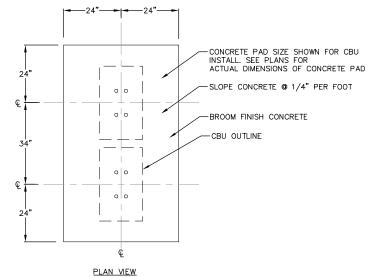

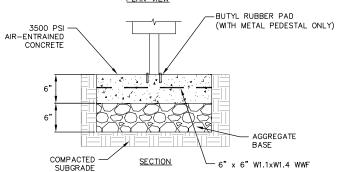

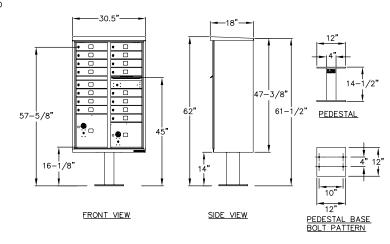

- CONCRETE SHALL HAVE A COMPRESSIVE STRENGTH OF 3,000 PSI @28 DAYS, CONTAIN 4% MIN. 6% MAX. AIR ENTRAINMENT AND BE PLACED WITH A 3.50 4.50 SLUMP IN ACCORDANCE WITH ACI 301 WELDED WIRE FABRIC SHALL BE PER ASTM A185/A185M

- EXPANSION BOLTS SHALL BE EQUIVALENT TO THE FOLLOWING PROVIDERS:
 EXPANSION BOLTS SHALL BE EQUIVALENT TO THE FOLLOWING PROVIDERS:
 HILTI KWIK BOLT II (WWW.US.HILTI.COM) 1/2" DIAMETER x 5-1/2" OVERALL LENGTH. GALVANIZED, CATALOG #: 00-453-696. KB II 12-512, STAINLESS STEEL; CATALOG #: 000-454-744. ENSURE THAT THE MINIMUM EMBEDMENT IN CONCRETE IS AT LEAST 3-1/2".
 ITW RAMSET REDHEAD TRUBOLT GALVANIZED (WWW.RAMSET-REDHEAD.COM), 1/2" DIAMETER x 7" OVERALL LENGTH; CATALOG NUMBER: WS-1270G. ENSURE THAT THE MINIMUM EMBEDMENT IN CONCRETE IS AT LEAST 4-1/6".
- RAWL STUD GALVANIZED (WWW.RAWL.COM), 1/2" DIAMETER x 5-1/2" OVERALL LENGTH; CATALOG NUMBER: 7724. ENSURE THAT THE MINIMUM EMBEDMENT IN CONCRETE IS AT LEAST 4".
- 4. A 3-CBU CONFIGURATION IS DEPICTED. A 2 OR 4-CBU CONFIGURATION MAY BE USED AS LONG AS THEY ARE ARRANGED IN GROUPS SUCH THAT THE OVERALL DIMENSION OF THE CONCRETE BASE DOES NOT EXCEED 16 FEET.






ngineering


ш

arri

AS SHOWN 2/5/2024


ALC roiect No:

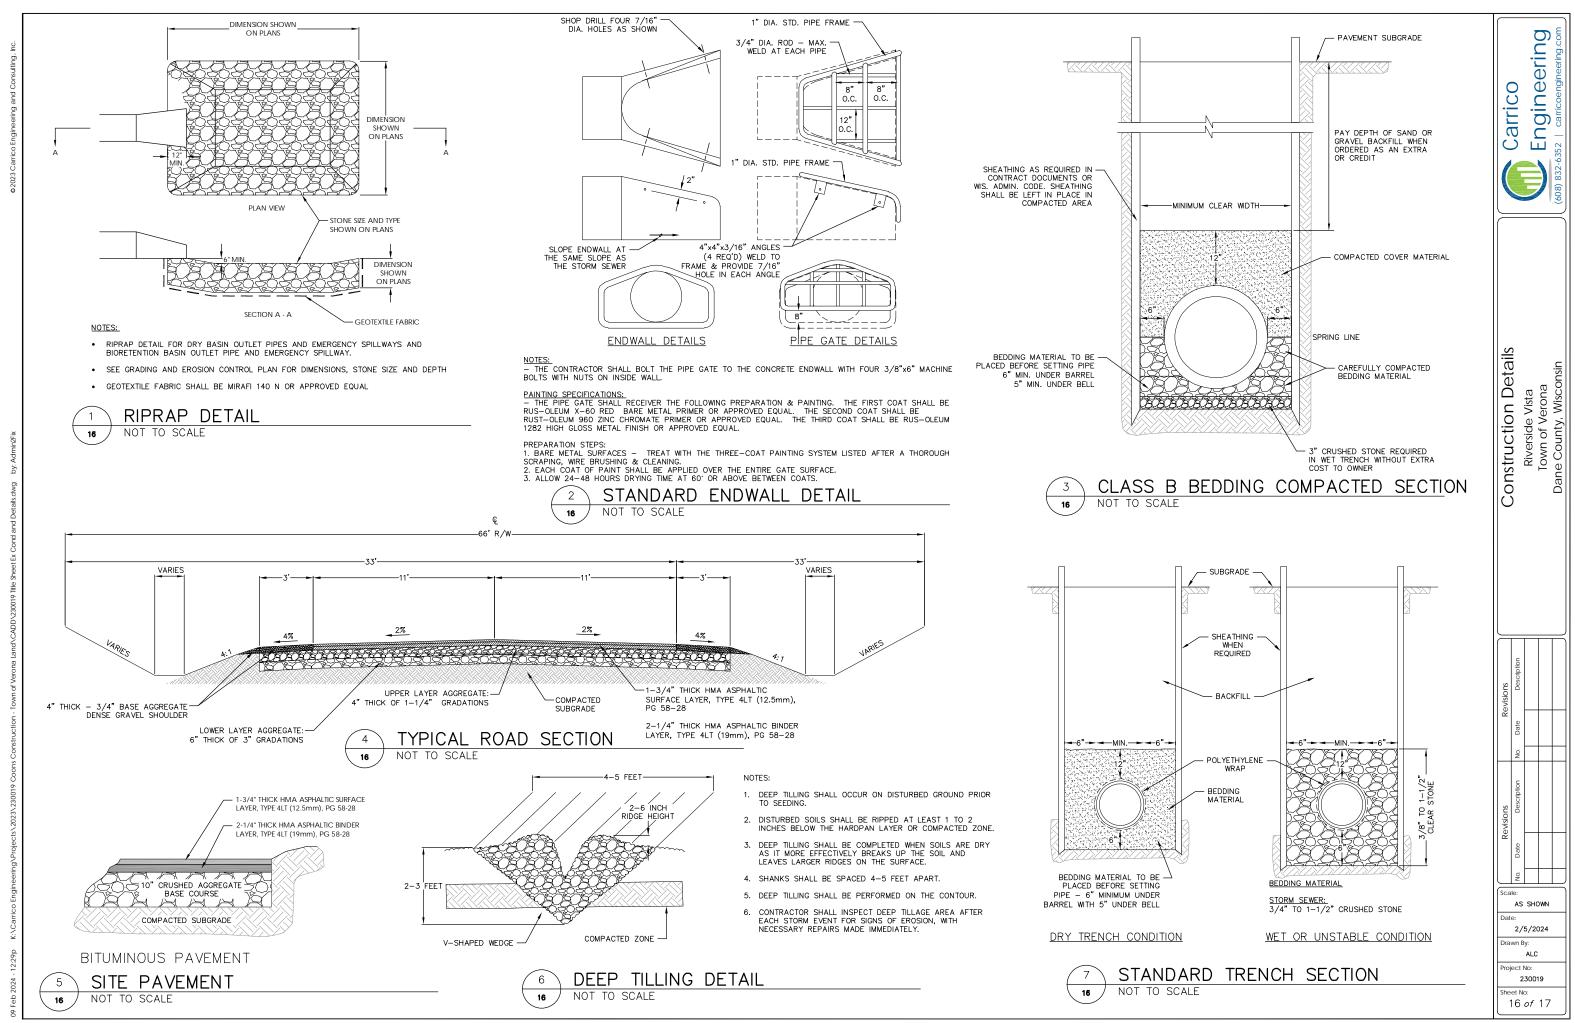

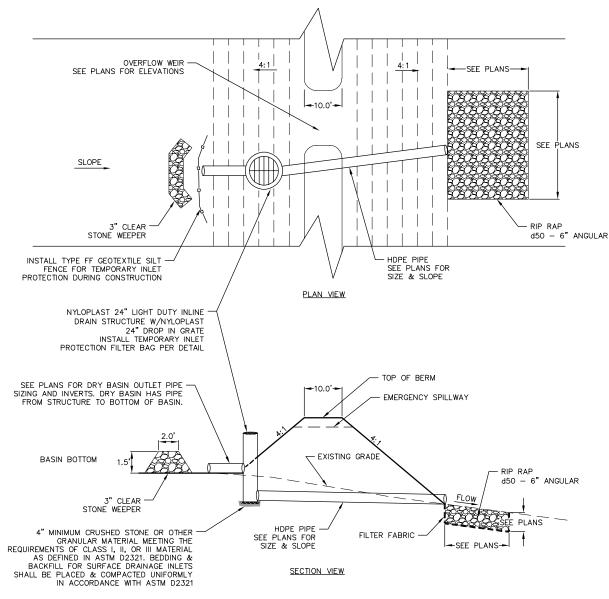


- SEE BASIN PLAN & PROFILE SHEETS FOR ALL TOP OF BERM ELEVATIONS, OVERFLOW WEIR LENGTH & ELEVATIONS, RIM ELEVATIONS FOR STRUCTURES, INVERT ELEVATIONS AND RIP RAP SIZING.
 BOTTOM OF DRY BASINS SHALL BE SLOPED TOWARD THE OUTLET TO ENSURE PROPER DRAINAGE AND PREVENT STANDING WATER.
- BOTTOM OF THE BASINS SHALL BE SEEDED WITH VECETATION THAT IS TOLERANT OF INUNDATION. SEED MIX SHALL BE AGRECOL RAINWATER RENEWAL MIX OR SIMILAR MIX APPROVED BY ENGINEER PLANTED AT 8 PLS (PURE LIVE SEED) LBS/ACRE.



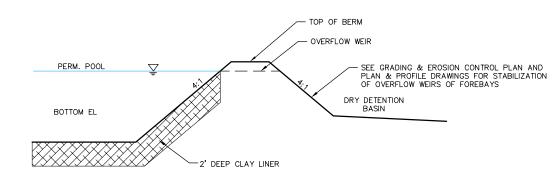


FOREBAY DETAIL NOT TO SCALE

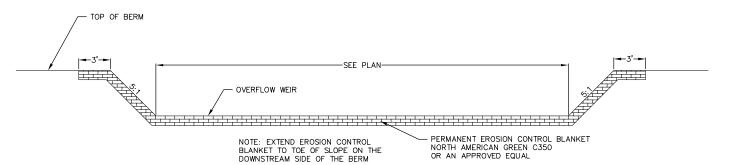

OVERFLOW WEIR

NOT TO SCALE

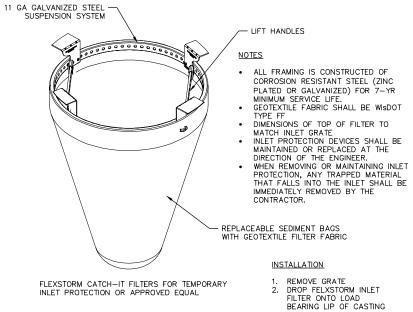

REPLACE GRATE

INLET PROTECTION DETAIL

NOT TO SCALE

Engineering arrico Ö

Construction Details Riverside Vista Town of Verona Dane County, Wiscons

AS SHOWN

2/5/2024

ALC roiect No:

230019 heet No 17 of 17